PROPERTY LINE 240.05 240.05' TERRACE ONE STORY BUILDING SIDEWALK PARKING PROPERTY LINE 240.05 SIDEWALK 30th AVENUE SOUTH

N SITE PLAN
1/16" = 1'-0"

NOTE: IF DRAWING SHEET IS NOT 24" X 36" THEN DRAWING IS NOT TO SCALE.

# SHEET INDEX

A1.1	SITE PLAN	M0.1	HVAC SCHEDULES
A2.1	DEMOLITION PLAN	M1.1	HVAC ROOF/DEMOLITION PLAN
A2.2	MAIN FLOOR PLAN	M1.2	EXISTING HVAC/FLOOR PLAN
	그는 마이에 시민이는 아이를 되지 않는데 되다.	M2.1	HVAC ROOF PLAN
A2.3	REFLECTED CEILING PLAN	M2.2	BASEMENT/MECHANICAL PLAN
A2.4	ENLARGED PLANS	M2.3	MECHANICAL DETAILS
A2.5	INTERIOR ELEVATIONS	E1.0	ELECTRICAL SYMBOLS & ABBR
A2.6	DOOR & ROOM FINISH SCHEDULES	E1.1	ELECTRICAL DEMOLITION PLAN
A2.7	DETAILS	E2.1	LIGHTING PLAN
MZ.I	DETAILS	E3.1	POWER PLAN
S1.0	STRUCTURAL DETAILS	E4.1	ONE-LINE DIAGRAM

# BUILDING DEPT. NOTES

CONSTRUCTION: ZONING: STRUCTURAL:  FIRE ZONE: BLDG. AREA: LOT AREA: LOT COVERAGE: BLDG. CUBAGE:	AS SHC 3 11,998 S 57,700 9,368 S	O G BUILDING W/ N OWN SQ. FT. SQ. FT.	MINOR STRUCTURAL RE	MODELING
OCCUPANCY:	A-3	DINING ROOM:	2,224 SQ. FT. 15 SQ. FT./PERSON	= 148 PEOPLE
	A-3	SOLARIUM:	700 SQ. FT. 15 SQ. FT./PERSON	= 47 PEOPLE
	В	LIBRARY:	478 SQ. FT. 50 SQ. FT./PERSON	= 10 PEOPLE
	B	KITCHEN:	421 SQ. FT. 200 SQ. FT./PERSON	= 3 PEOPLE
	В	OFFICE/ RECEPTION	2,059 SQ. FT. 100 SQ. FT./PERSON	= 21 PEOPLE

# LEGAL DESCRIPTION

LEGAL DESCRIPTION: LOTS 1 TO 4, INCLUSIVE AND LOTS 11 TO 14, INCLUSIVE, BLOCK 21, BURKE'S 2nd ADDITION TO THE CITY OF SEATTLE, RECORDED IN VOL. 1 OF PLATS, PAGE 248, RECORDS OF KING COUNTY, WASHINGTON.

# **ABBREVIATIONS**

. (				
	AUX CH CLNG CO CONC CONT CPT CT DEMO DIA, DIAM DIMS EQ EX,EXIST F.E. FIN FLR FOIC FOIO FTG GL GLB	AMOUNT AUXILIARY COAT HOOK CEILING CLEAN OUT CONCRETE CONTINUOUS CARPET CERAMIC TILE DEMOLITION/DEMOLISH DIAMETER DIMENSIONS EQUAL	LONG MAX MIN MTL MV O.C. O.D. P PLAM PPT RD PTD REF SD SS STOR SUFF SV TME TP U.O.N. VCT VIF WC WD WR WS WWF	MAXIMUM MINIMUM/ MINUTE METAL MICROWAVE ON CENTER OUTSIDE DIAMETER PAINT PLASTIC LAMINATE PRESSURE PRESERVATIVE TREA ROOF DRAIN PAPER TOWEL DISPENSER REFLECTED SOAP DISPENSER STAINLESS STEEL STORAGE SUFFICIENT SHEET VINYL

# CONSTRUCTION DOCUMENTS 6/22/98

DONALD HING ARCHITECTS

2107 Elliott Avenue Suite 305 Seattle, WA 98121

PHONE (206) 443-9939 FAX (206) 443-9891

CENTRAL AREA

SENIOR CENTER

500 30th Avenue South Seattle, WA 98144


NO.	DATE	DESCRIPTION
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		7 14 14 14 14 14 14 14 14 14 14 14 14 14
******		A STATE OF THE STA

SITE PLAN

APPROVED FOR ADVERTISING CITY OF SEATTLE

APPROVED BY DRAWN: AM
CHECKED: MAJ
PROJECT NO.: 9719
S H E E T EXECUTIVE SERVICES DEPARTMENT

DWIGHT D. DIVELY
Director of Executive Services

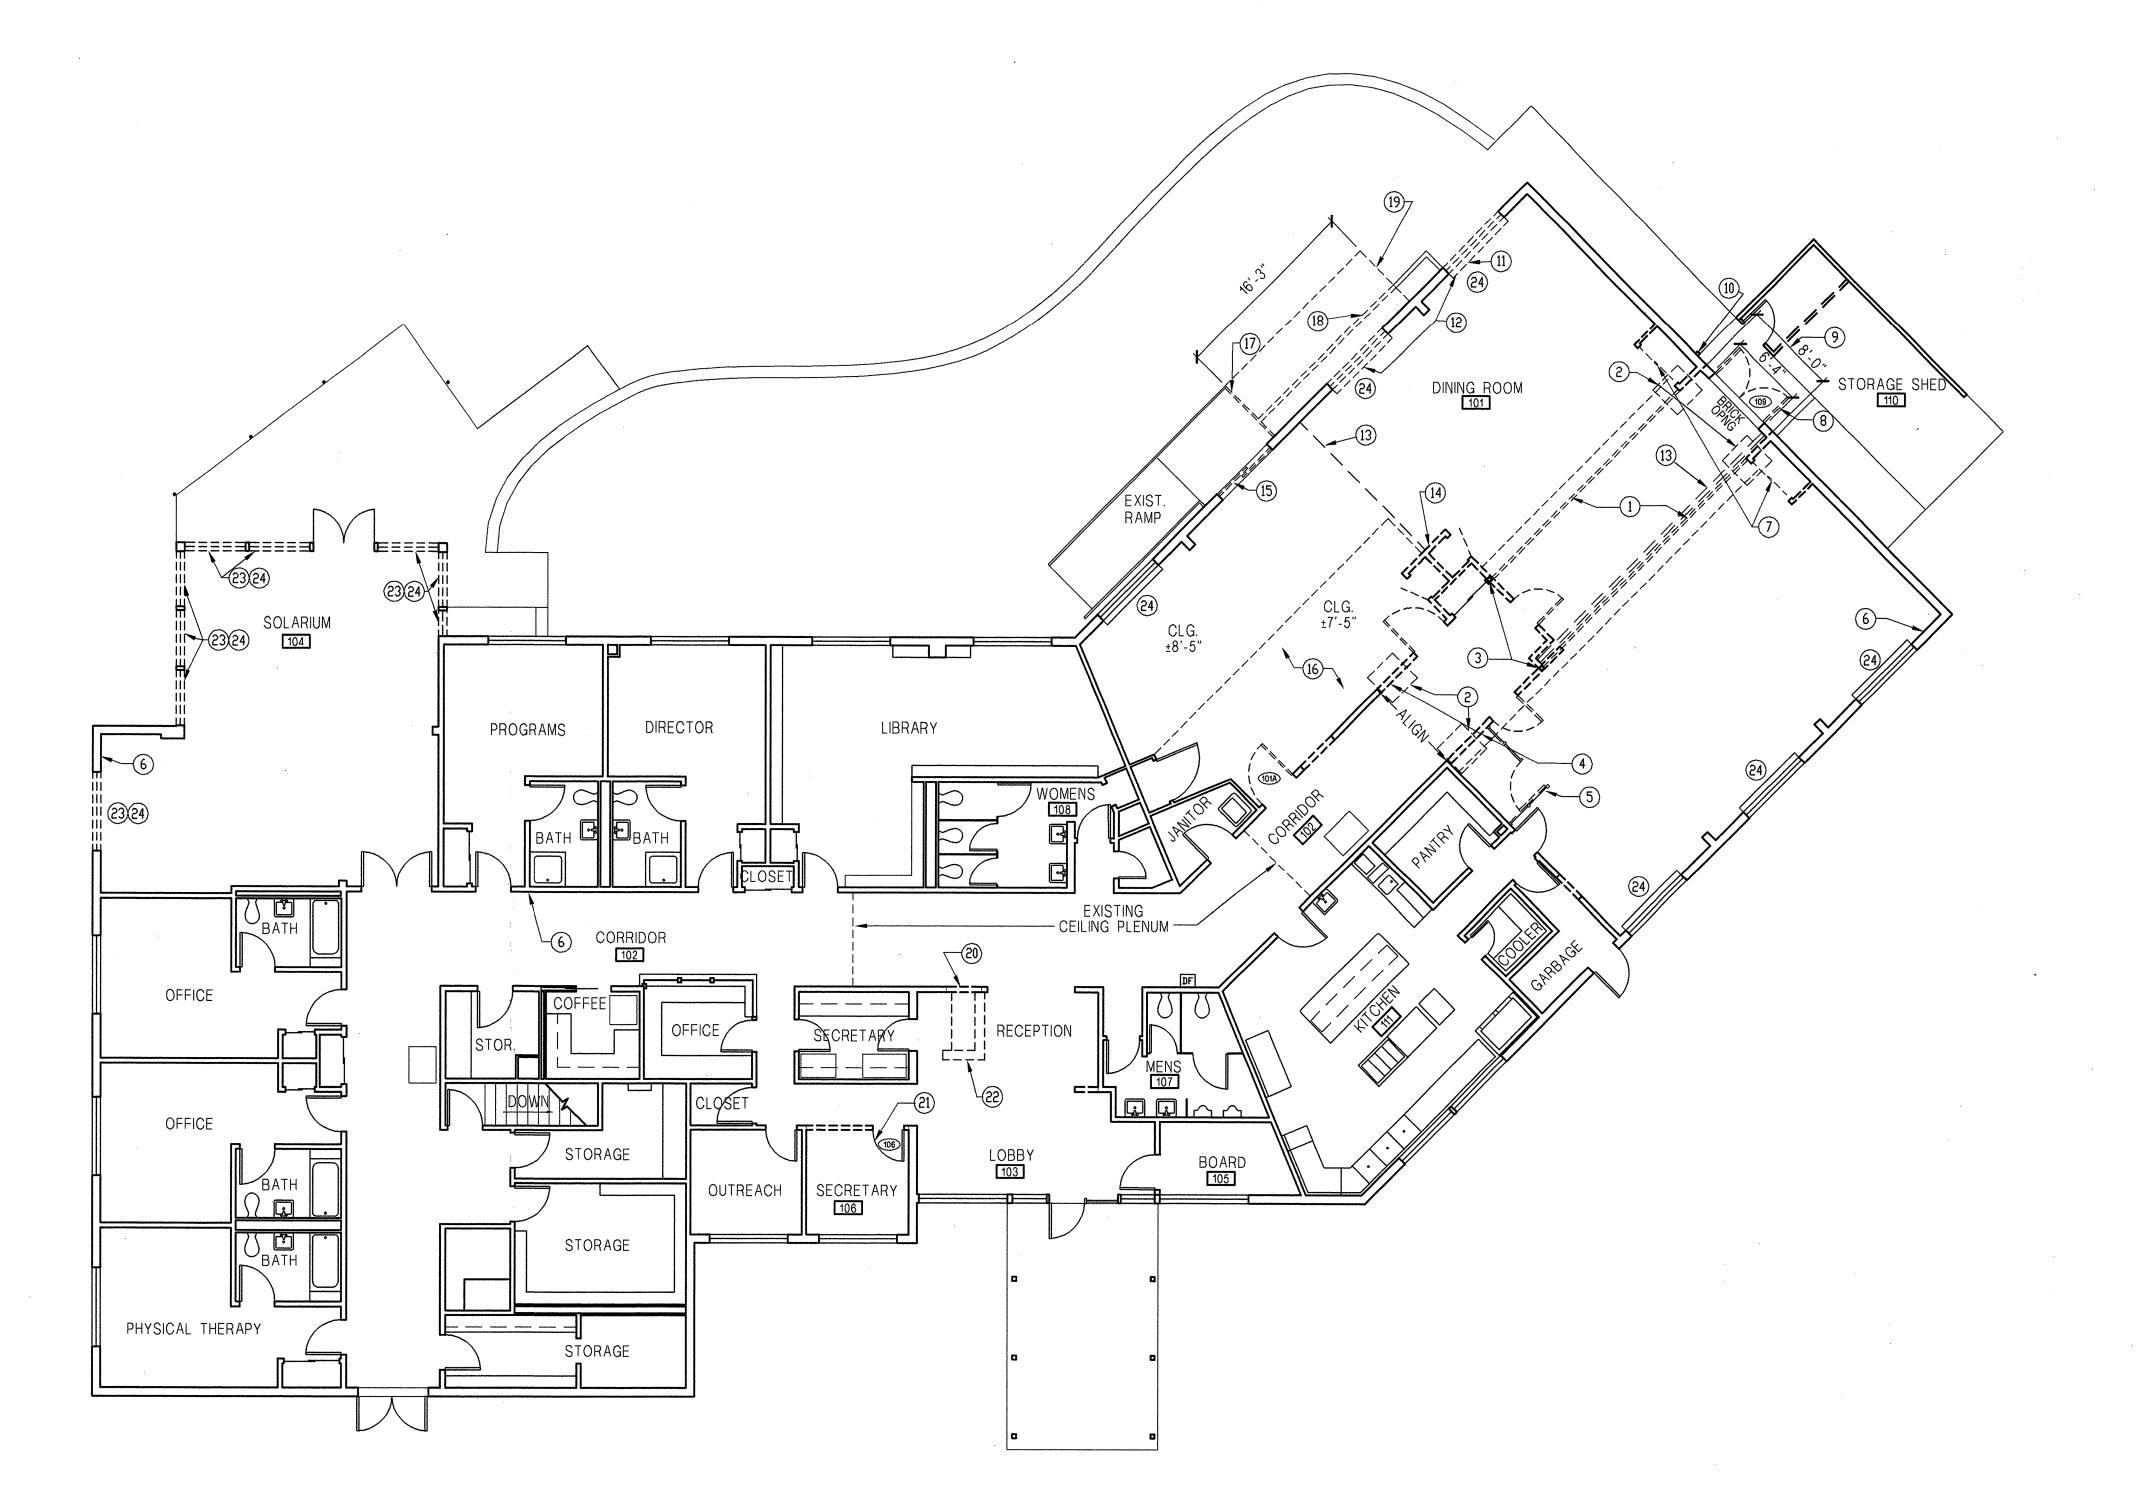

DONALD KING ABCHILECTS

2107 Elliott Avenue Suite 305 Seattle, WA 98121 PHONE (206) 443-9939 FAX (206) 443-9891



# CENTRAL AREA SENIOR CENTER

500 30th Avenue South Seattle, WA 98144

#### DEMO NOTES:

- 1 REMOVE EXIST. 5 1/8 x 16 1/2 GLBs
- REMOVE SUFF. AMT. CONC. TO ACCOMMODATE NEW FTG.
- 3) REMOVE EXISTING 4x6 WOOD POSTS
- 4 REMOVE CORRIDOR WALLS AND DOORS
- 5 REMOVE OFFICE WALLS AND DOOR
- 6 REMOVE 4" RUBBER BASE ENTIRE PERIMETER OF DINING ROOM, SOLARIUM, & CORRIDOR
- 7) REMOVE CLOSET WALLS AND DOORS
- 8 REMOVE EXIT DOORS, FRAME & HARDWARE

ROOF TEMPORARILY

- 9 REMOVE WALL & BRICK VENEER THIS 8' WIDE SECTION 10 REMOVE 4x4 WD COLUMN, SUPPORT
- 11) REMOVE WALL BELOW WINDOW TO NEW SILL HT. SEE WINDOW SCHED.
- REMOVE 6'-8" x 4'-0" WINDOWS & 8'-0" x 2'-6" RADIATOR BELOW WINDOW 13 REMOVE ACCORDIAN ROOM DIVIDER
- 14) REMOVE CLOSETS
- 15) REMOVE SLIDING DOORS
- (6) REMOVE CEILING PLENUM IN THIS ROOM. PLENUM REMAINS IN CORRIDOR
- 17) REMOVE EX. MTL. GUARDRAIL.
- (18) REMOVE 4" CONC. FOR NEW LANDING.
- (19) REMOVE CONC. THIS AREA FOR NEW LANDING (SEE PLAN).
- 20) DEMO OPENING 36" X 30" TOP OF OPENING @ 6'-10" AFF
- (21) REMOVE, SHORE & REUSE EXISTING DOOR, FRAME & HARDWARE
- 22 REMOVE EXISTING RECEPTION DESK
- 23 REMOVE EXIST. SINGLE PANE GLASS FR. WOOD FRAMES TO ALLOW FOR GLASS

REPLACEMENTS ALL WINDOWS THIS RM. (24) REMOVE CURTAINS & RODS

### CONSTRUCTION DOCUMENTS 6/22/98

REVISIONS

# **DEMOLITION PLAN**

DRAWN: AM CHECKED: MAJ PROJECT NO.: 9719

APPROVED FOR ADVERTISING DWIGHT D. DIVELY Director of Executive Services

SEATTLE, WA \_\_\_\_\_19\_\_\_


BY CONTRACTING COMPLIANCE MANAGER


APPROVED BY EXECUTIVE SERVICES DEPARTMENT CITY OF SEATTLE


DIR. FACILITY SERVICES DIV.


DIR. ARCHITECTURE AND ENGINEERING DATI

S H E E T

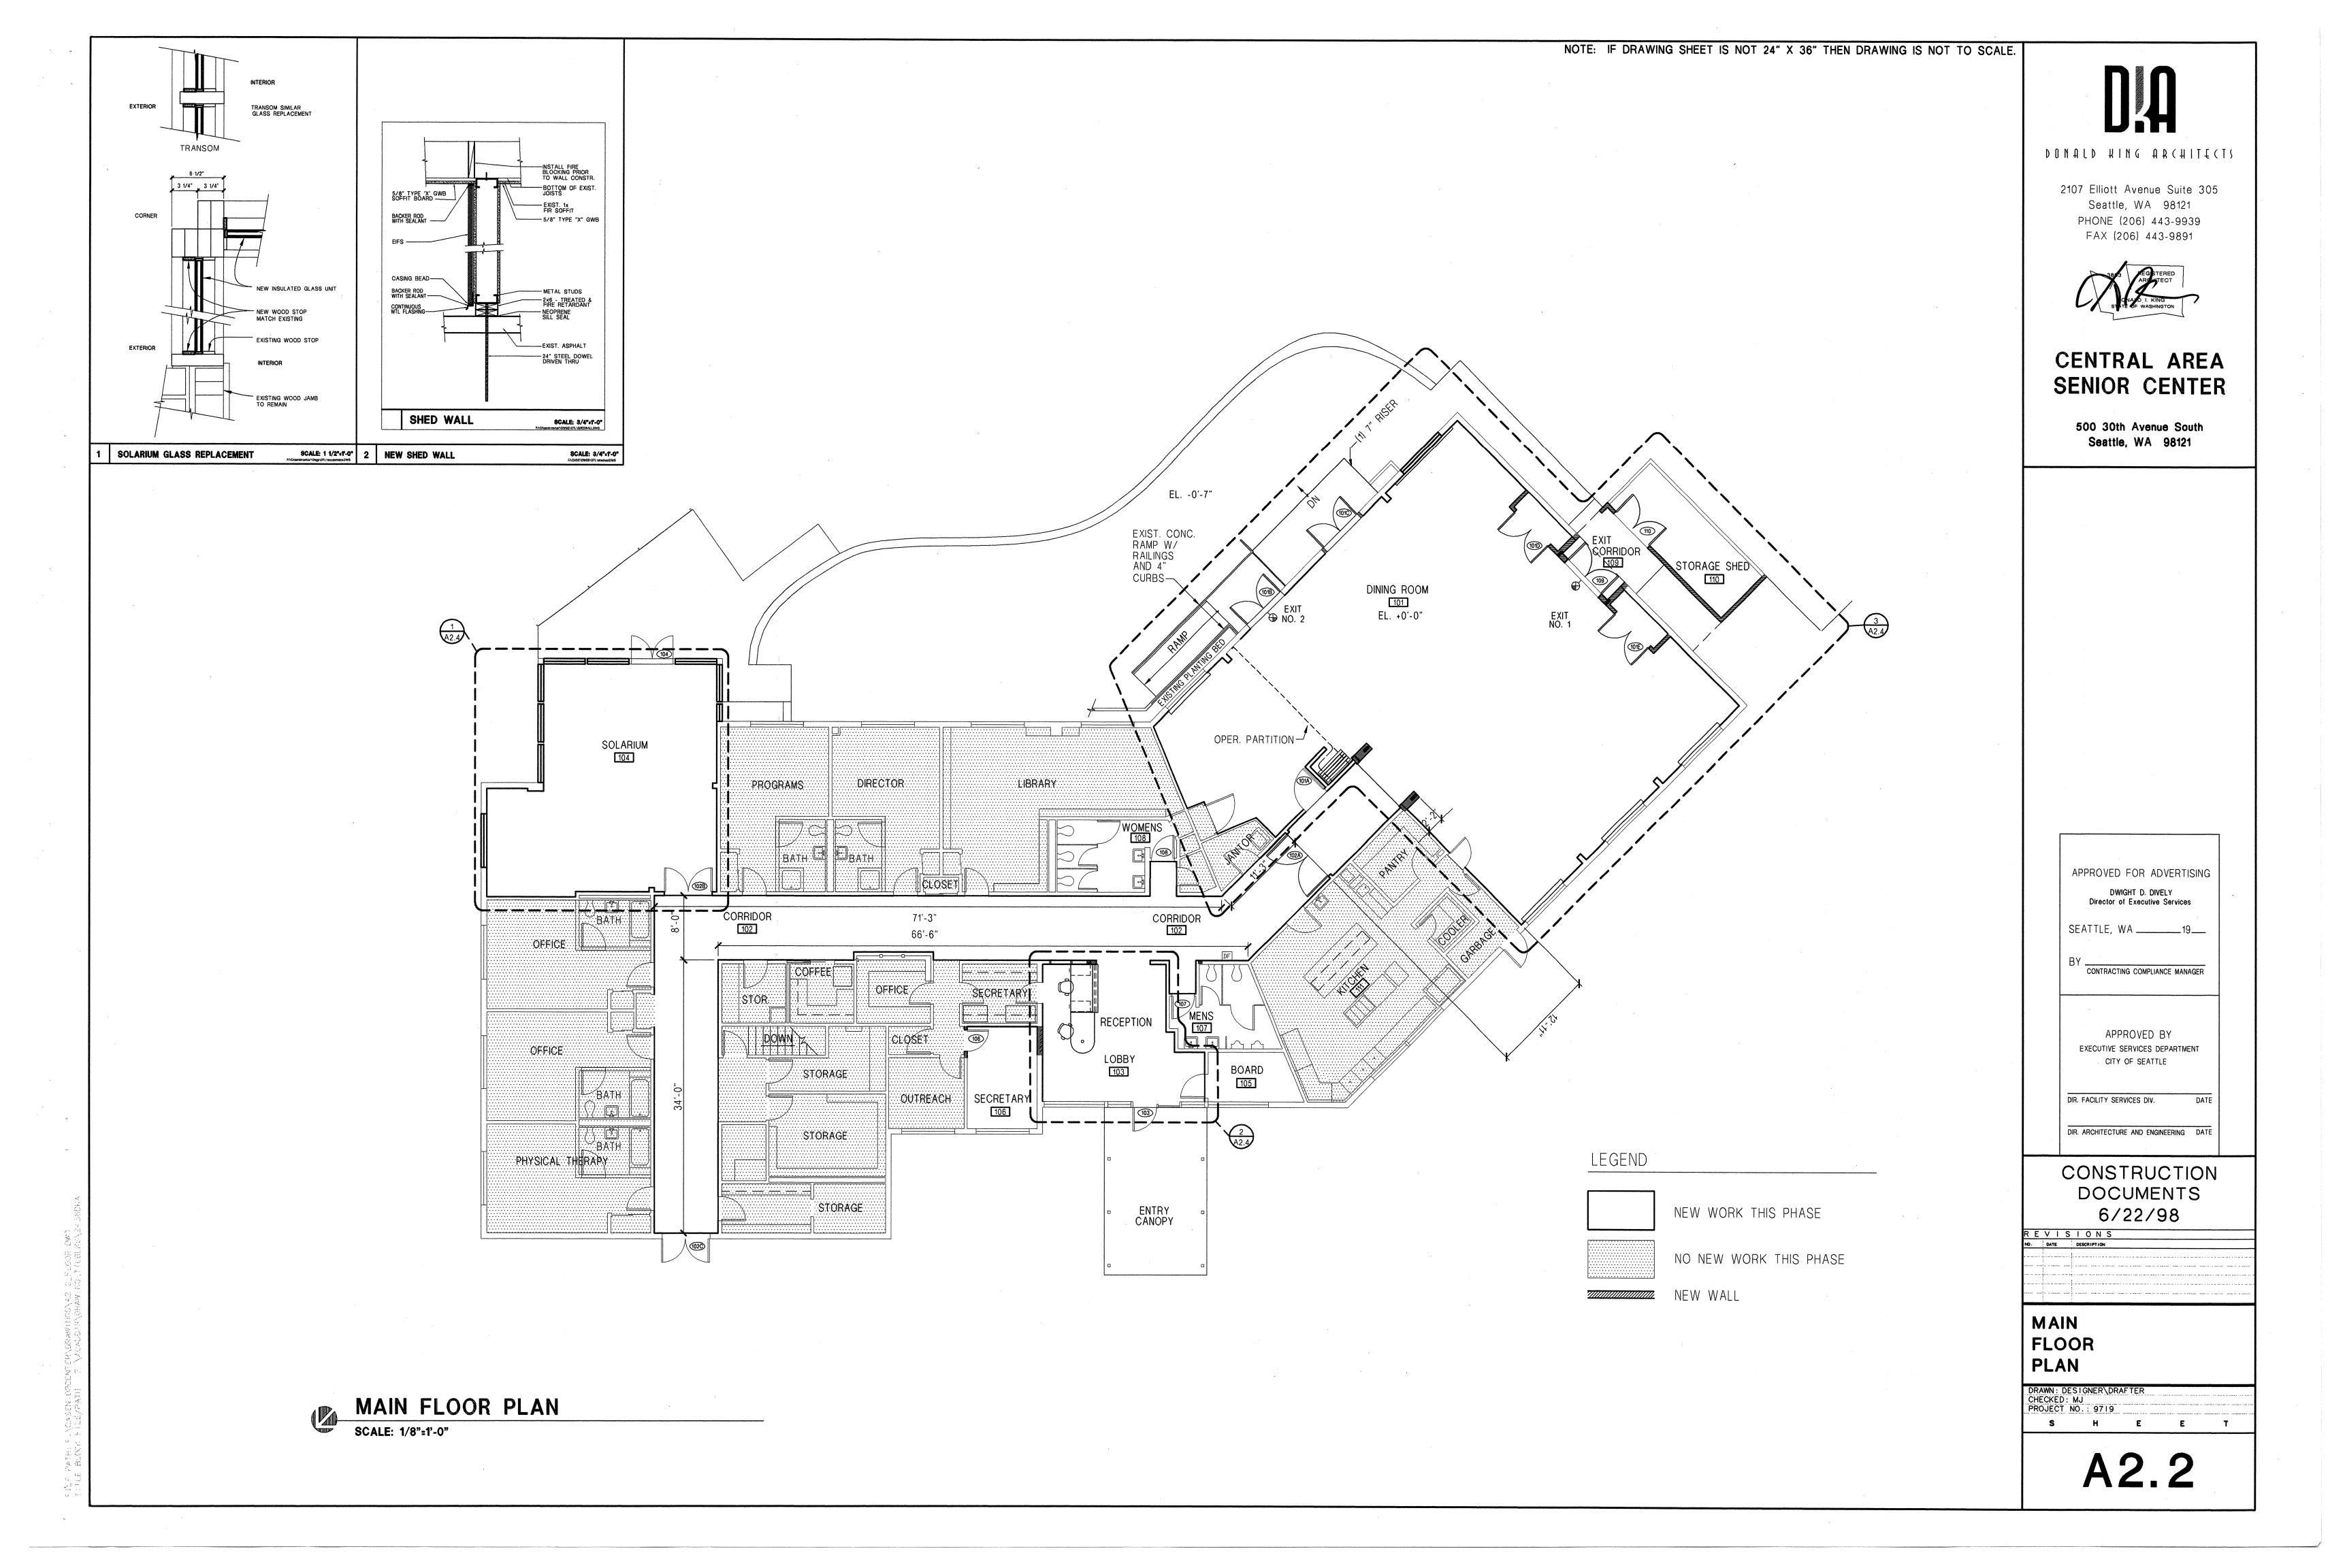

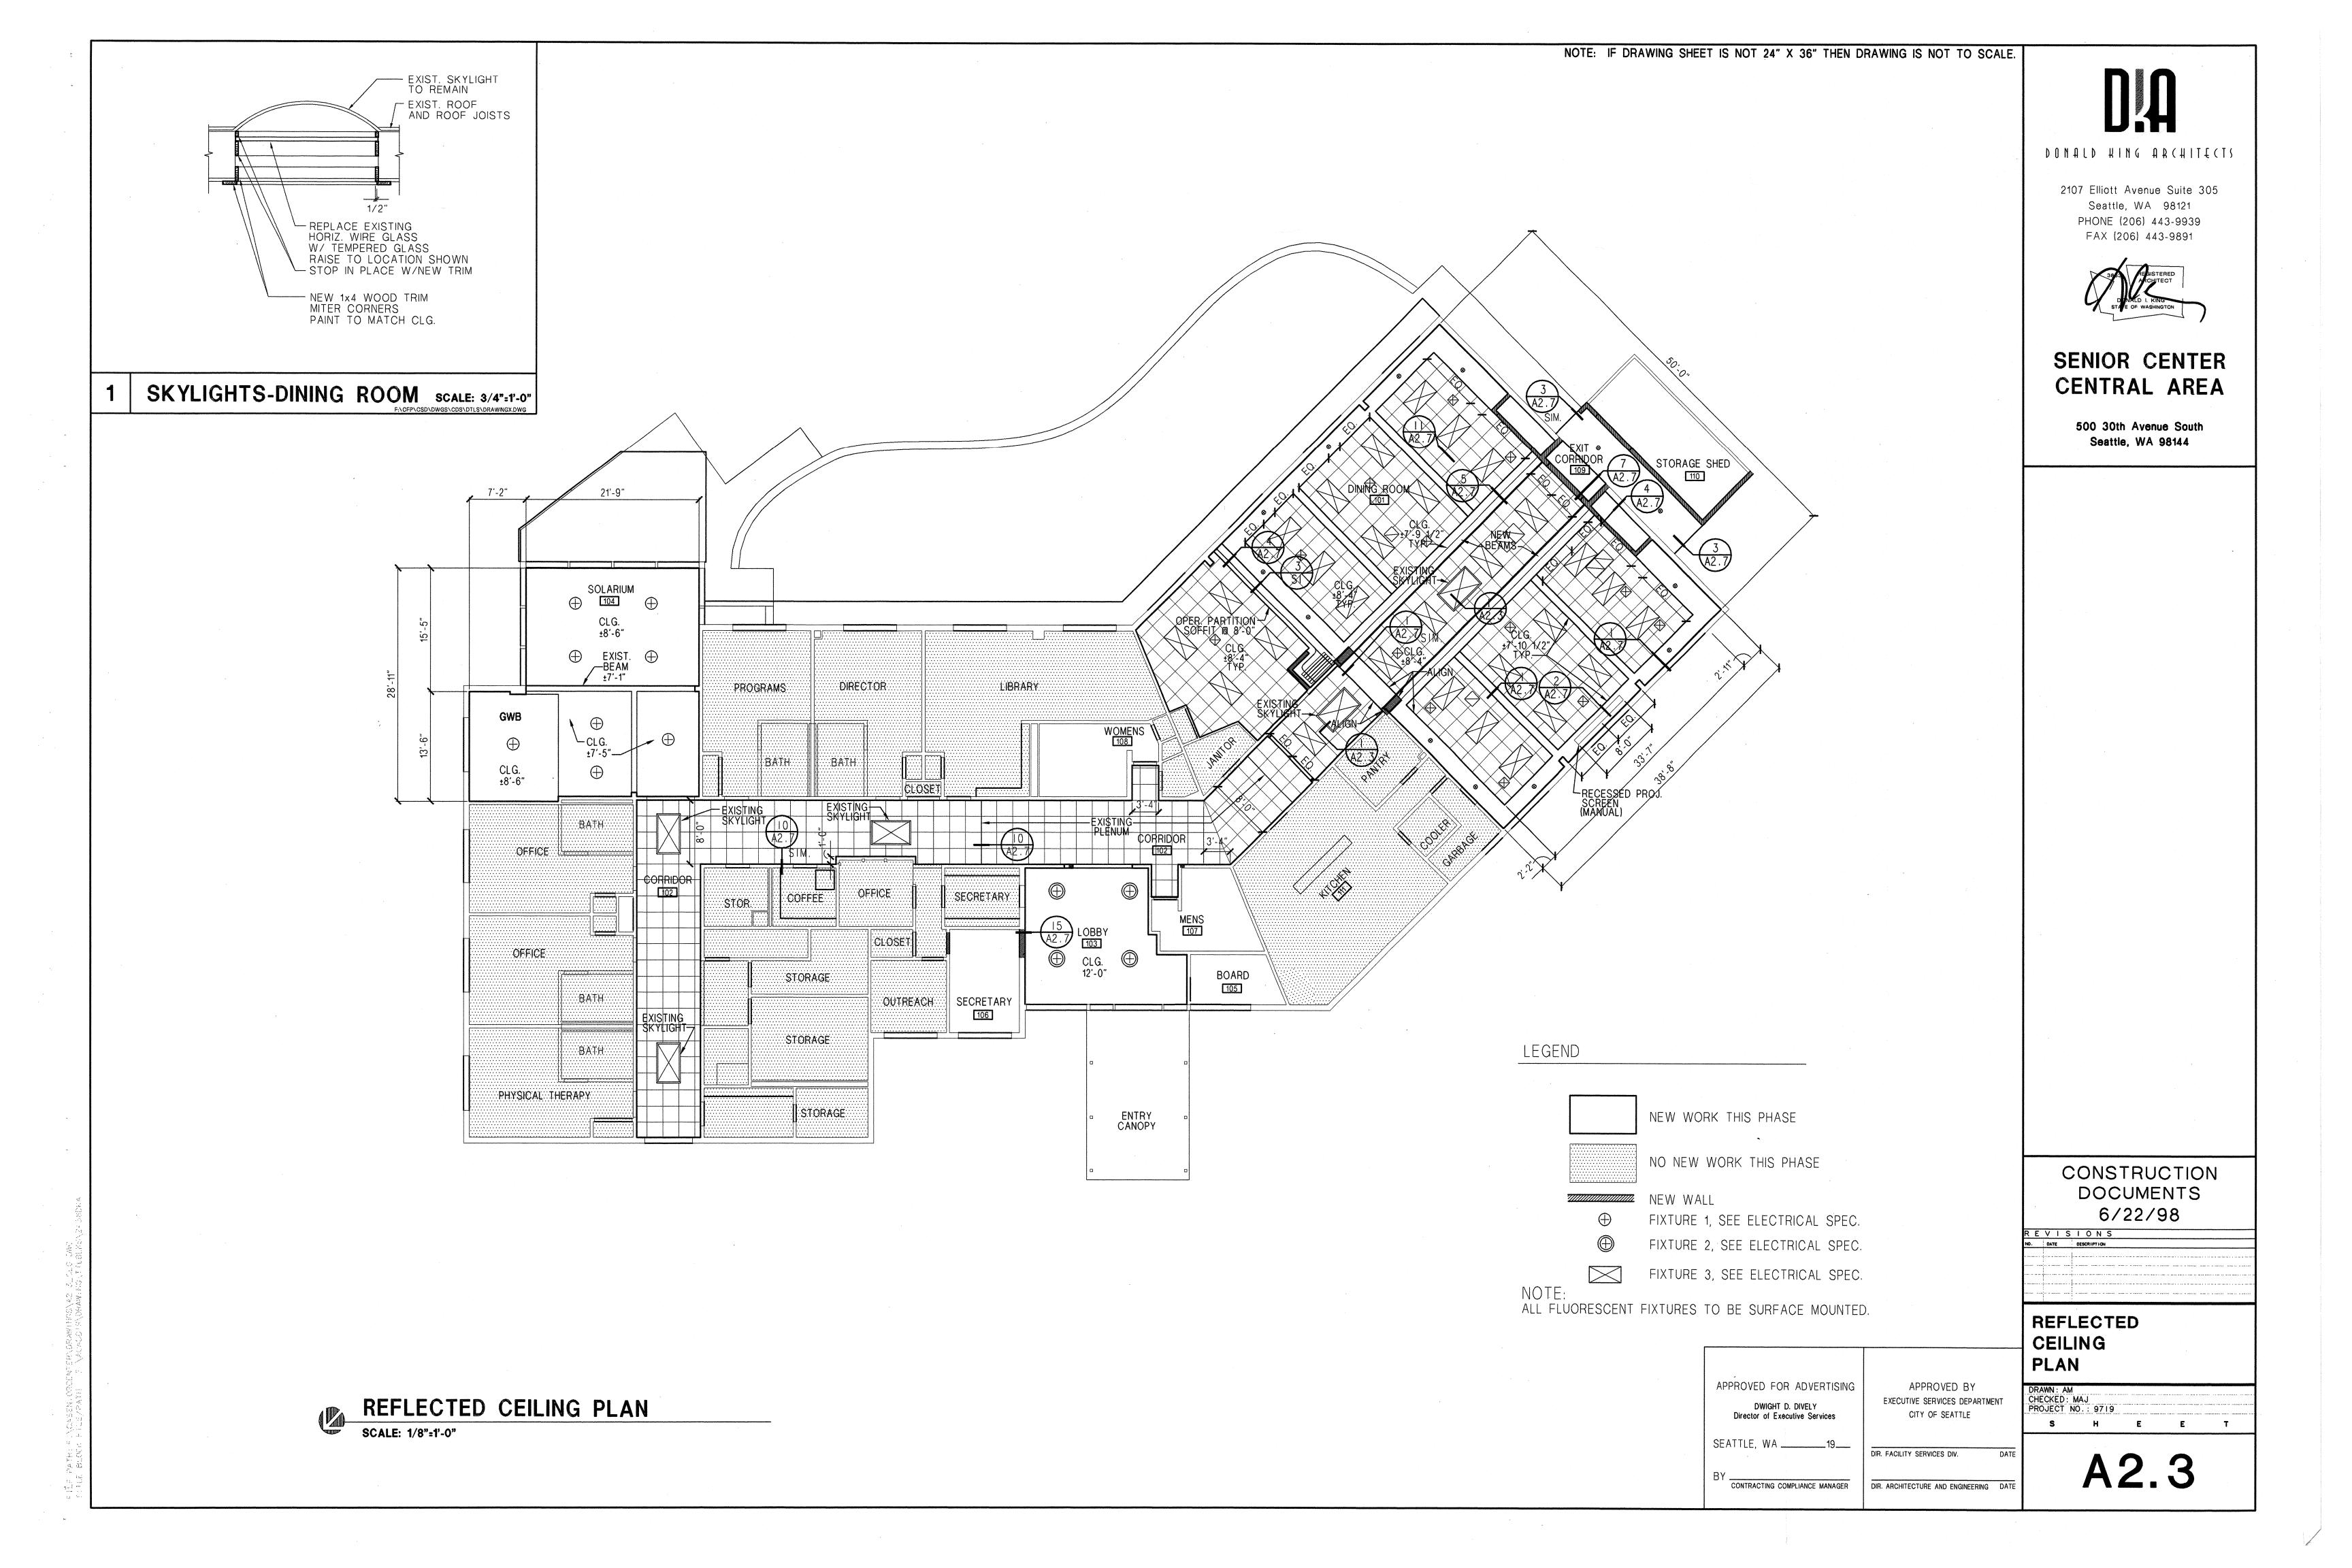

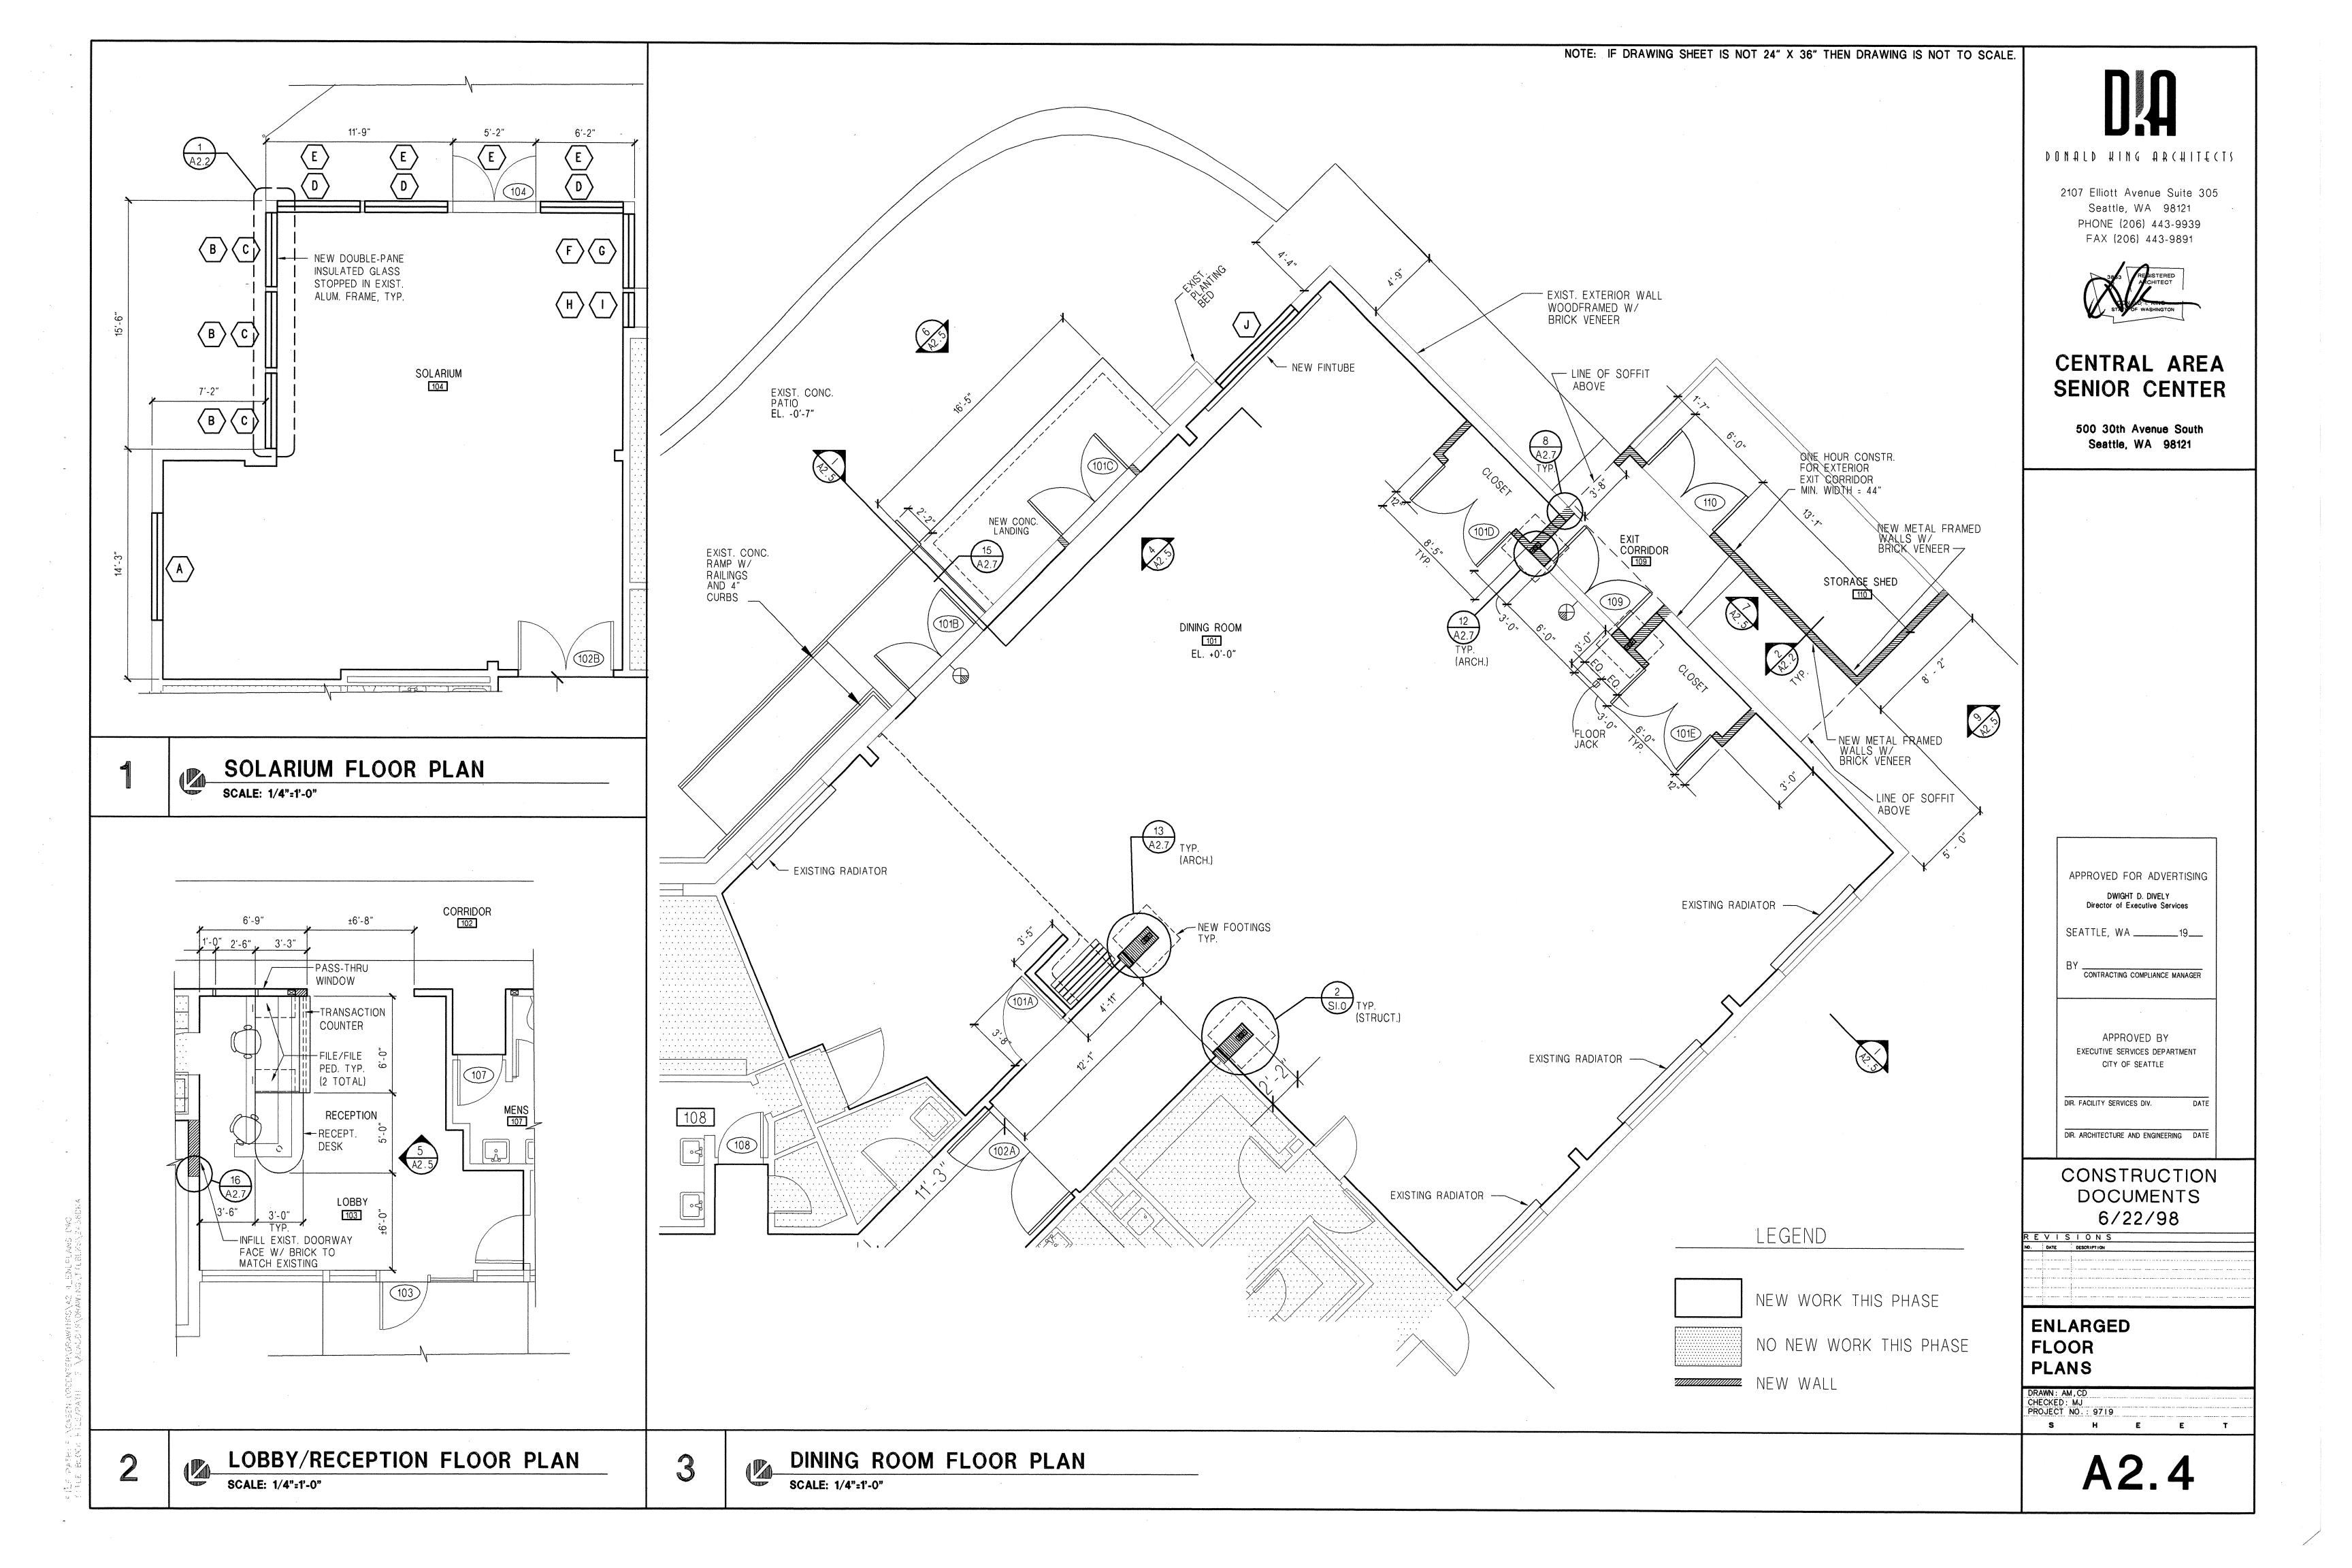

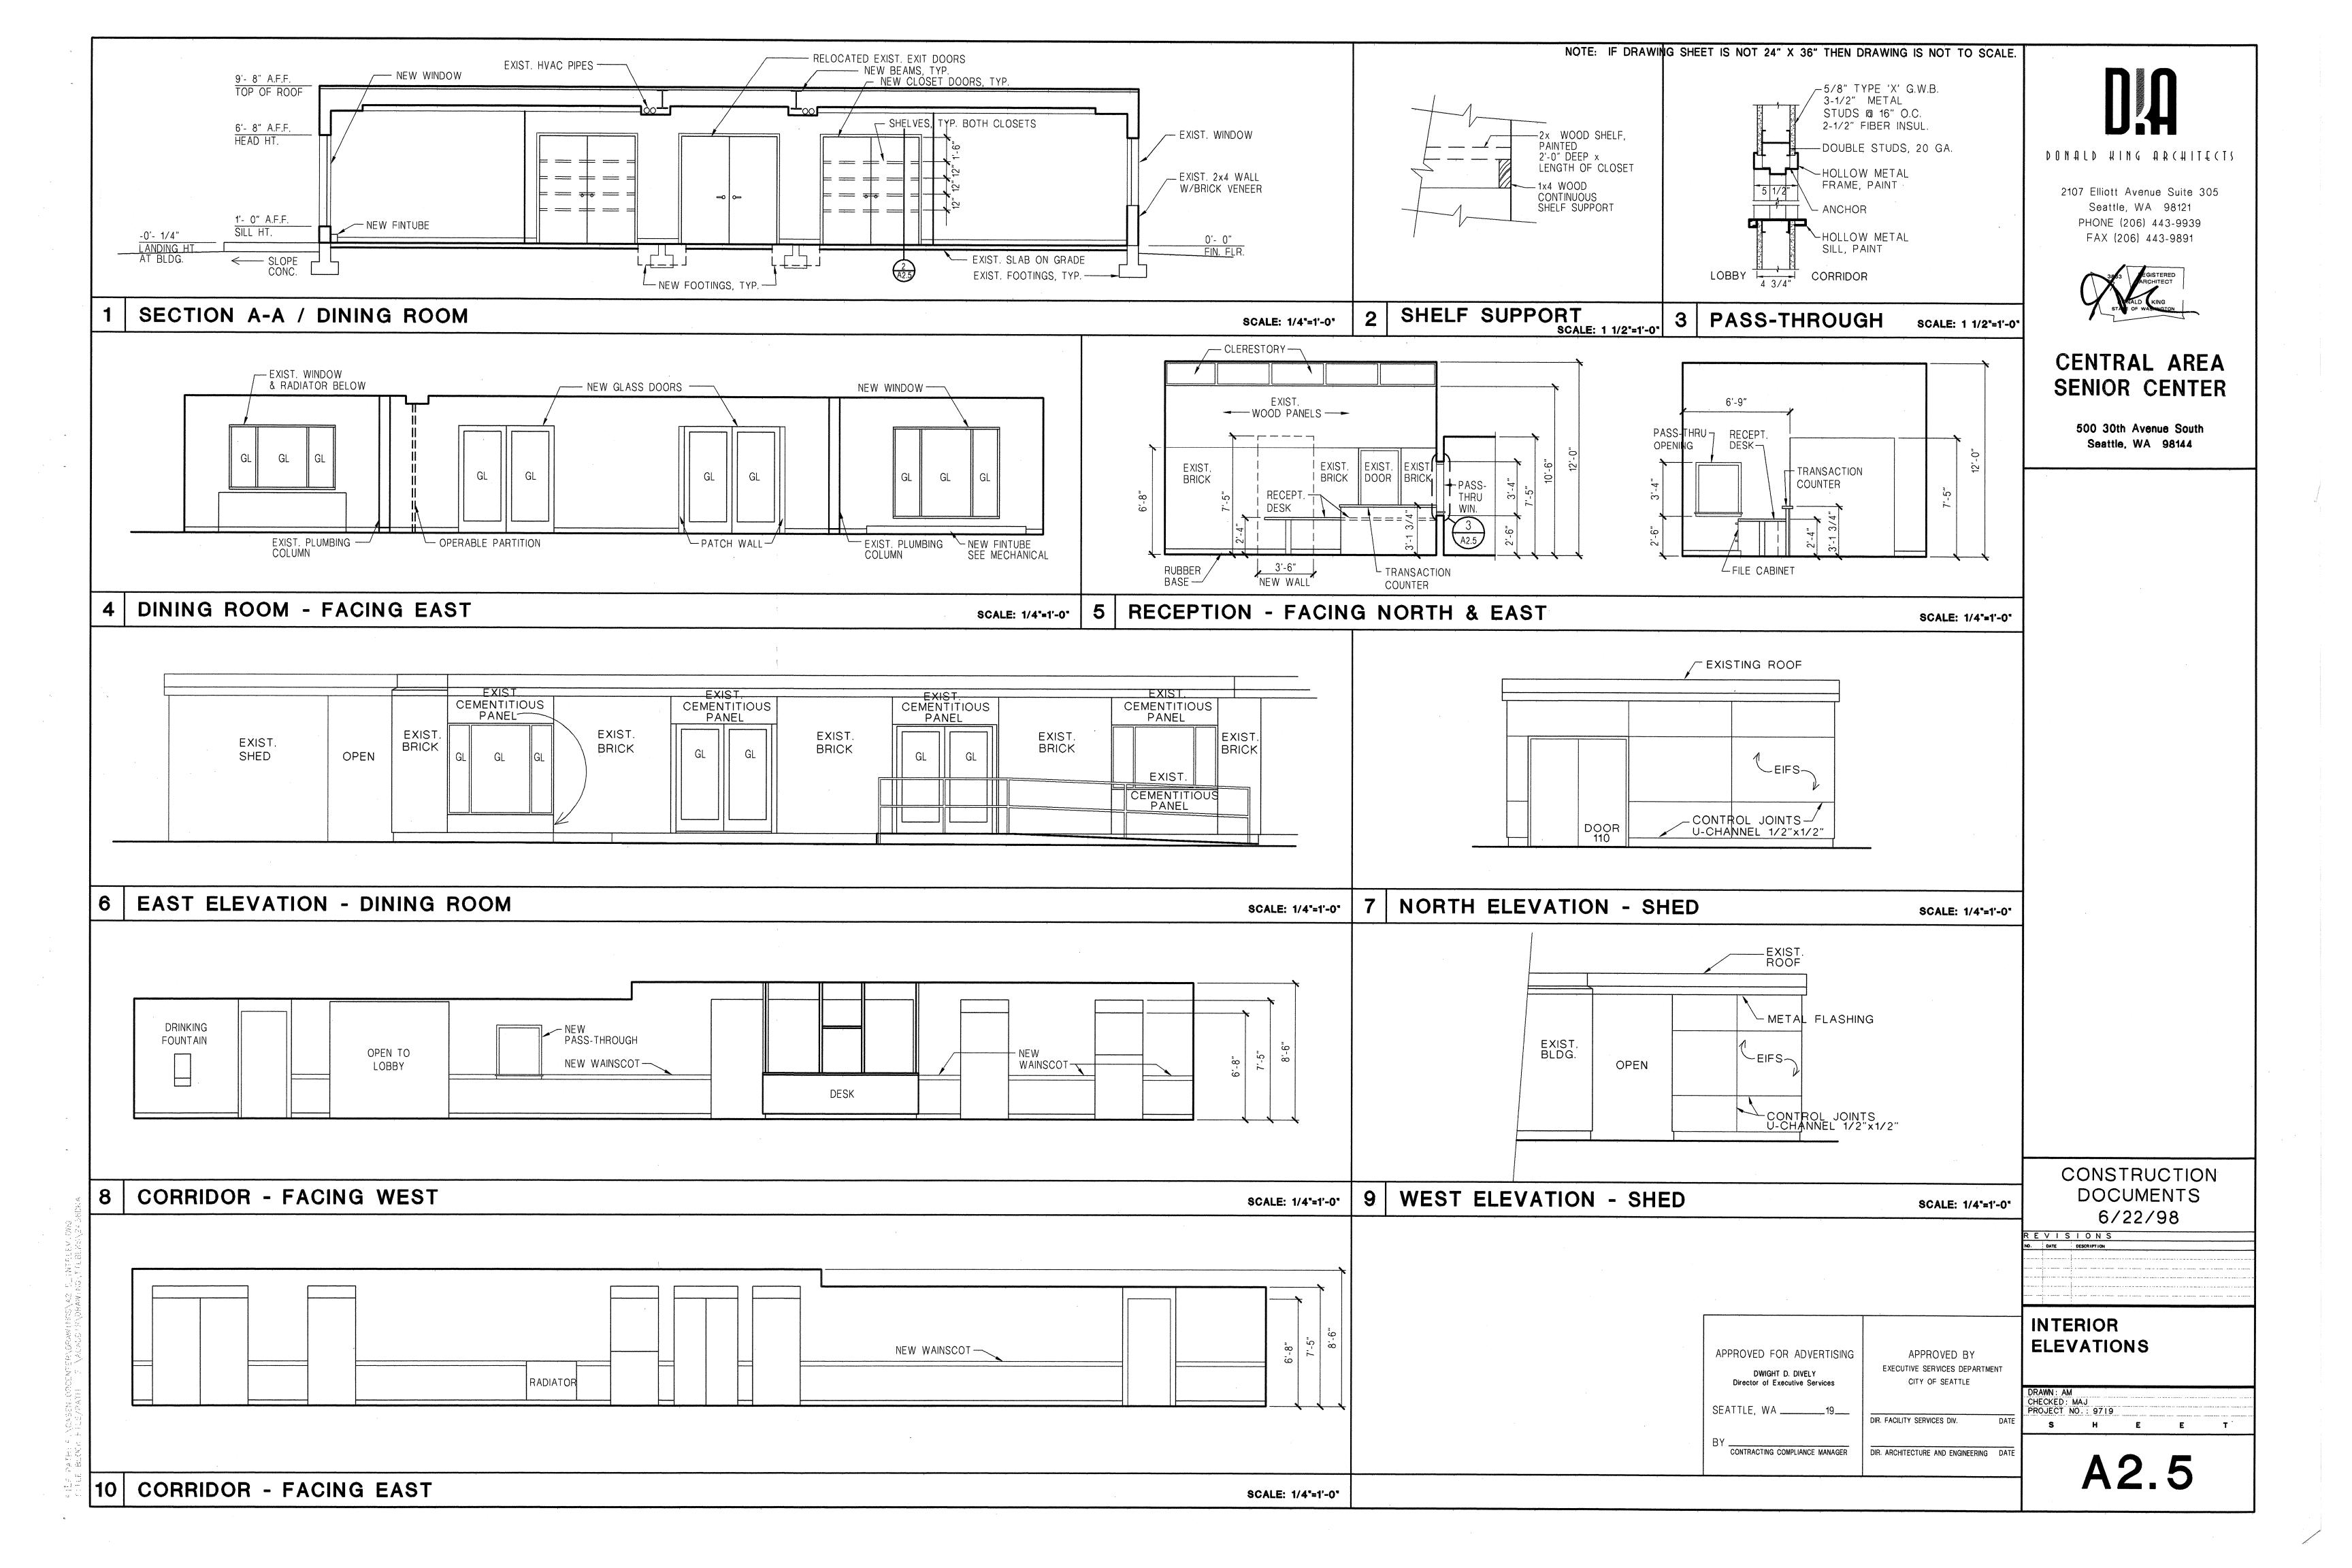

ROOM	ROOM	FLOOR		BASE	WALLS								CEILING		REMARKS	
NO.	NAME				NORTH		SOUTH		EAST		WEST					
		MAT'L	FINISH	MAT'L	MAT'L	FINISH	MAT'L	FINISH	MAT'L	FINISH	MAT'L	FINISH	MAT'L	FINISH		
01	DINING ROOM		SV	R	GWB	Р	GWB	Р	GWB	Р	GWB	Р	GWB/ACT	Р	· · · · · · · · · · · · · · · · · · ·	
)2	CORRIDOR		CPT	R	GWB	Р	GWB	P	GWB	Р	GWB	Р	ACT	Р	· ·	
03	LOBBY		SV	R	GWB	Р	GWB	Р	GWB	Р	GWB	Р	ACT	Р		
) 4 	SOLARIUM		CPT	R	GWB	Р	GWB	Р	GWB	Р	GWB	Р	GWB	Р	, 2	
05	SECRETARY		-	_	PATCH	Р	PATCH	Р	-	-	-	-	-	_		
<b>06</b>	MEN'S ROOM (EXISTING)	EXIST.	~	-			-	-		<u> </u>	-	-	•	-	1	
07	WOMEN'S ROOM (EXISTING)	EXIST.		. <u>-</u>	-	-	-	_		<b>1</b>	_	_	_	_	1	
08	STORAGE SHED	EXIST.	-	NA	GWB	Р	NA	NA	NA	NA	GWB	р	NA			


- 1. EXISTING MEN'S & WOMEN'S ROOMS TO REMAIN. ALL PLUMBING FIXTURES TO REMAIN. VENTILATION FAN TO BE INSTALLED.
- 2. GWB OVER EXISTING 150 S.F. ACOUSTICAL CEILING TILES. EXISTING GWB AREAS TO REMAIN. PAINT ENTIRE CEILING.

GWB:GYPSUM WALLBOARD SV=SHEET VINYL

P=PAINT


PLAM=PLASTIC LAMINATE

CPT=CARPET ACT:ACOUSTICAL CEILING TILE

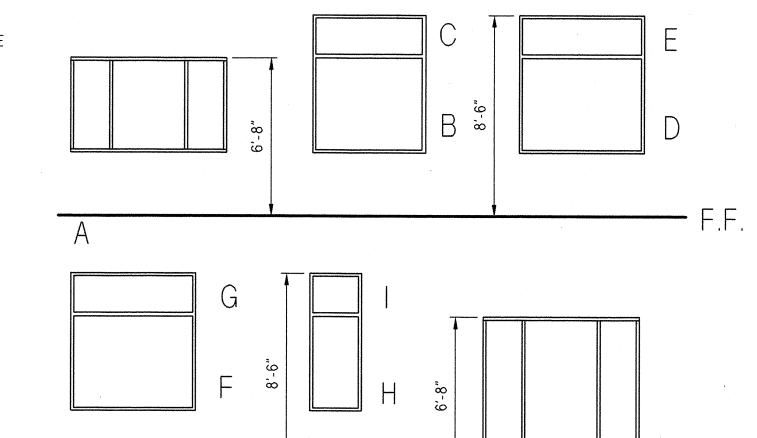

WINDOW TYPES

DOOR TYPES

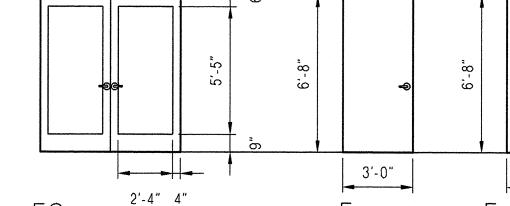

# 3'-0" 2'-4" 4" <u>FG</u>

DOOR	ABBREVIATIONS		
ANOD	ANODIZED	1	A 1.4

V V1 V L	ANIODIZED		1 0031010 777		107	EXIST.
ANOD D	ANODIZED DUTCH	L A M	LAMINATED PAINT		108	EXIST.
F	FLUSH	ST	STEEL		109	6'-0" X 6'-8"
FG G,GL	FULL GLASS GLASS	CL TEMP	CLEAR TEMPERED GLASS		110	6'-0" X 6'-8"
HM	HOLLOW METAL	WD	WOOD			
MTL	METAL	WG	WIRE GLASS		REMARKS:	
					1)	EXIST. FRAME TO BE
					2)	EXIST. INTERIOR DOO
					31	EXIST. INTERIOR WOO
				<b>→ → → → → → → → → →</b>	4)	HINGED CLOSET DOO
					5)	FIRE EXIT DOOR
				2	1 200	
	<del>                                      </del>				5	
	232					
U			CPT 1			
	CPT 1 23		CPI I			
			23 10000	FINISH FL	OOR LEGEND	
				CPT 1	BENTLEY/Co-ordin	nates Longitude
Ω		<b>108</b>		CPT 2 (TI		2246 Sunda
S	0 23			CPT 3 (TI		2259 Coconut
	32			Sheet Viny	yl 1 COLOR 51018	
Щ				Sheet Viny		
				Sheet Viny		
	u /\ ll .			<u>~</u>		

NOTE: IF DRAWING SHEET IS NOT 24" X 36" THEN DRAWING IS NOT TO SCALE.

3-1/2" STUDS © 2-1/2" FI  DOUBLE  HOLLOW FRAME, I	METAL PAINT  16" O.C. STUDS, 20 GA.


TYP. HM DOOR HEAD/JAMB SCALE: 3"=1'-0"

										F:\CFP\CSD\DWG\$\CD\$
			WINDO	W SCI	HEDULE					***************************************
SYMBOL	QTY.	SIZE	TYPE	М	GLASS TYPE	FINISH		DETAIL		į
		WXH					HEAD	JAMB	SILL	REMARKS
Α	1	6'-8" x 4'-0"	WINDOW	AL	DBL. INS.	ANOD	2/A2.6 SIM.			
В	3	4'-8" x 4'-0"	STOPPED GL	WD	DBL. INS.	PÄINT	4/A2.6	4/A2.6	4/A2.6	
C	3	4'-8" x 1'-6"	STOPPED GL	WD	DBL. INS.	PAINT	4/A2.6	4/A2.6	4/A2.6	
D	3	5'-2" x 4'-0"	STOPPED GL	WD	DBL. INS.	PÀINT	4/A2.6	4/A2.6	4/A2.6	
E	4	5'-2" x 1'-6"	STOPPED GL	WD	DBL. INS.	PAINT	4/A2.6	4/A2.6	4/A2.6	
F	1	4'-6" x 4'-0"	STOPPED GL	WD	DBL. INS.	PÁINT	4/A2.6	4/A2.6	4/A2.6	
G <sup>.</sup>	1	4'-6" x 1'-6"	STOPPED GL	WD	DBL, INS.	PAINT	4/A2.6	4/A2.6	4/A2.6	
Н	1	2'-0" x 4'-0"	STOPPED GL	WD	DBL. INS.	PAINT	4/A2.6	4/A2.6	4/A2.6	
	1	2'-0" x 1'-6"	STOPPED GL	WD	DBL. INS.	PAINT	4/A2.6	4/A2.6	4/A2.6	
J	1	6'-8" x 5'-6"	WINDOW	AL	DBL. INS.	ANOD	2/A2.6 SIM.			

				D O	OR	S C H	E D U L	E					
NO.	SIZE		DOOR FRAME		FRAME		FIRE	GLASS		DETAIL		HDWR.	REMARKS
	WXH	TYPE	MAT'L	FINISH	MAT'L	FINISH	RATING	TYPE	HEAD	JAMB	SILL	GROUP	
101A	3'-0" X 6'-8"	D	WD	CL	EXIST.	CL		<u></u>	~ ~				1
101B	6'-0" X 6'-8"	FG-FG	MTL	Р	HM	P		TEMP.	2/A2.6	2/A2.6	1/A2.6	1	5
101C	6'-0" X 6'-8"	FG-FG	MTL	Р	НМ	Р		TEMP.	2/A2.6	2/A2.6	1/A2.6	1	
101D	6'-0" X 6'-8"	F-F	WD	CL	НМ	P						2	4
101E	6'-0" X 6'-8"	F-F	WD	CL	НМ	P						2	4
102A	6'-0" X 6'-8"	F-F	WD	CL	НМ	Р			<b>-</b> -			3	3
102B	EXIST.						,						
102C	EXIST.			** **									
103	EXIST.				·								
104	EXIST.		7.		~ ~				••				
106	EXIST.												2
107	EXIST		<b>~ ~</b>										
108	EXIST.												
09	6'-0" X 6'-8"	F-F	MTL	Р	НМ	Р	20 MIN.	***	8/A2.7	12/A2.7	1/A2.6	4	5
10	6'-0" X 6'-8"	F-F	MTL	Р	НМ	Р	20 MIN		8/A2.7			5	


## REMARKS:

- 1) EXIST. FRAME TO BE REINSTALLED. SEE SHT A2.2 FOR DOORSWING.
- 2) EXIST. INTERIOR DOOR, FRAME, AND HARDWARE TO BE REINSTALLED. SEE SHT A2.2 FOR DOORSWING.
- 3) EXIST. INTERIOR WOOD DOORS TO BE REUSED AND REINSTALLED. NEW FRAME AND HARDWARE NECESSARY. SEE SHT A2.2 FOR DOORSWING.
- 4) HINGED CLOSET DOORS WITH DEADBOLT LOCKS EACH LEAF. SEE SHT A2.2 FOR DOORSWING.
- 5) FIRE EXIT DOOR

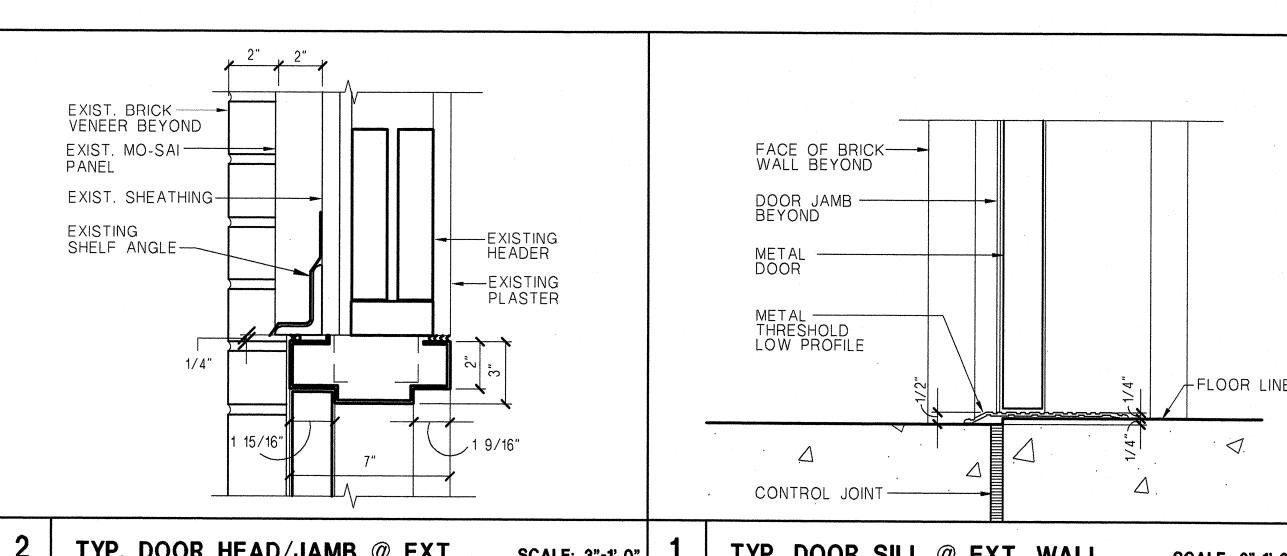

DONALD HING ARCHITECTS

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# CENTRAL AREA SENIOR CENTER

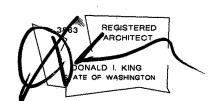500 30th Avenue South Seattle, WA 98144

APPROVED FOR ADVERTISING DWIGHT D. DIVELY
Director of Executive Services SEATTLE, WA \_\_\_\_\_19\_\_\_ BY \_\_\_\_\_\_\_CONTRACTING COMPLIANCE MANAGER APPROVED BY EXECUTIVE SERVICES DEPARTMENT CITY OF SEATTLE

# CONSTRUCTION DOCUMENTS 6/22/98

DIR. ARCHITECTURE AND ENGINEERING DATE

DIR. FACILITY SERVICES DIV.

REVISIONS
NO. DATE DESCRIPTION

**ROOM FINISH** & DOOR SCHEDULE

DRAWN: AM CHECKED: MAJ PROJECT NO.: 9719 S H S E T

A2.6

FINISH FLOOR PATTERNS

SCALE: 1/16" = 1'- 0"


Sheet Vinyl 4 COLOR 51047

TYP. DOOR HEAD/JAMB @ EXT.

SCALE: 3"=1'-0"

TYP. DOOR SILL @ EXT. WALL

SCALE: 3"=1'-0"

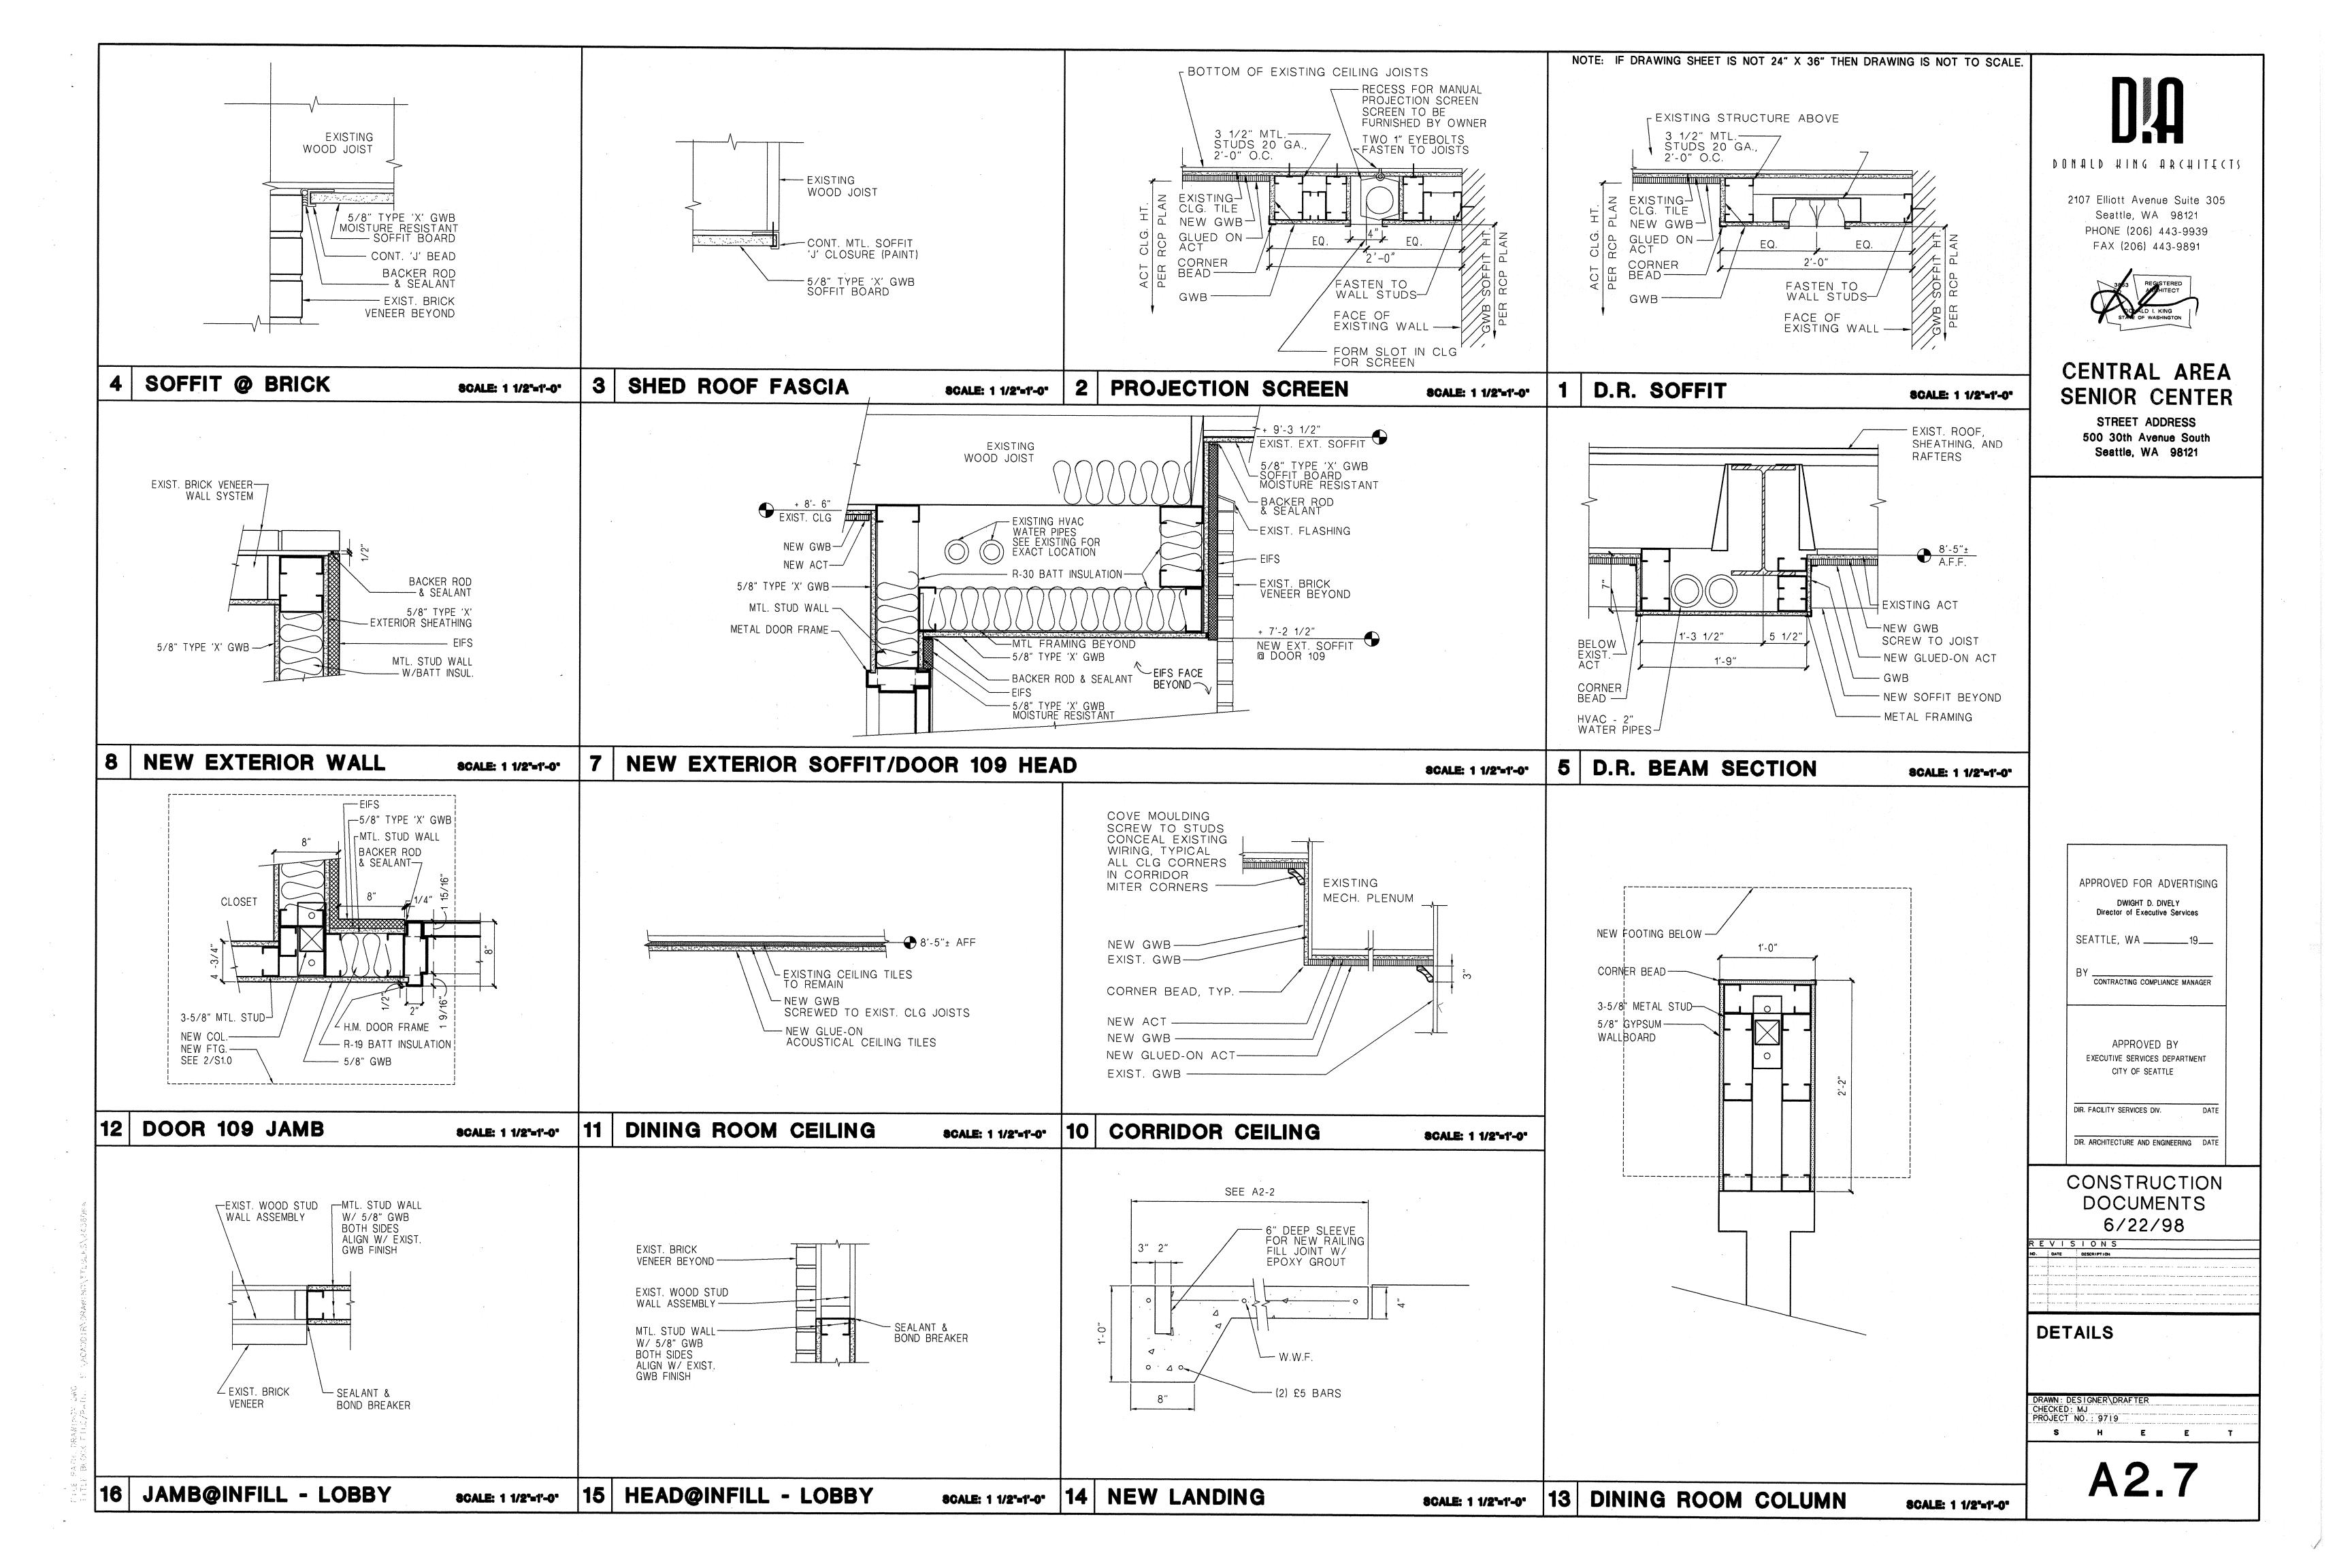

# ELECTRICAL SYMBOLS & ABBREVIATIONS

#### **GENERAL**

INDICATES NOTES THIS SHEET. REFERENCE TARGET, UPPER HALF INDICATES DETAIL'S NUMBER, LOWER HALF INDICATES DETAIL'S SHEET NO.

P-31 PROVIDE AN INDIVIDUAL 'HOME RUN' FROM THIS LOCATION TO THE PANEL AND CIRCUIT DESIGNATION INDICATED (i.e. PANEL 'P', CIRCUIT #31).
UNLESS OTHERWISE INDICATED ALL CONDUIT SHALL BE SIZED PER N.E.C. BY THE ELECTRICAL CONTRACTOR

SWITCH - SINGLE POLE (SUBSCRIPTS a,b, etc., DENOTES FIXTURE CONTROLLED)

SWITCH - WITH PILOT LIGHT

MOTOR RATED DISCONNECT SWITCH PHOTOELECTRIC CONTROL

FLUORESCENT FIXTURE, (SUBSCRIPT INDICATES SWITCHING CONTROL). EMERGENCY BALLAST.

FLUORESCENT FIXTURE, (SUBSCRIPT INDICATES SWITCHING CONTROL).

FLUORESCENT STRIP FIXTURE

SURFACE MOUNTED FIXTURE WALL MOUNTED FLUORESCENT FIXTURE

WALL MOUNTED FIXTURE RECESSED DOWNLIGHT.

EMERGENCY WALL PACK FIXTURE

WALL MOUNTED EXIT SIGN. FIXTURE TYPE "EX", SEE FIXTURE SCHEDULE

EXIT SIGN — DIRECTIONAL ARROWS AS INDICATED. FIXTURE TYPE "EX", SEE FIXTURE SCHEDULE

X = TYPE (SEE FIXTURE SCHEDULE)

## **RECEPTACLES**

DUPLEX RECEPTACLE.

DOUBLE DUPLEX RECEPTACLE.

FLUSH FLOOR BOX WITH DUPLEX RECEPTACLE. WALKER #RFB SERIES WITH RFB4-FAKMII ACTIVATION

#### **EQUIPMENT**

MAIN DISTRIBUTION PANEL BRANCH CIRCUIT PANEL

TELEPHONE TERMINAL BOARD (TTB)

MOTOR CONNECTION.

DISCONNECT SWITCH

MECHANICAL EQUIPMENT (SEE SCHEDULE).

#### ELECTRICAL RISER

- FUSED SWITCH FUSE OR CURRENT LIMITER

GROUND

FEEDER SIZE, SEE FEEDER SCHEDULE

CONTACTOR

#### **COMMUNICATIONS**

SIMPLEX DATA OUTLET.

#### FIRE ALARM

SMOKE DETECTOR.

#### **SECURITY**

SECURITY SYSTEM KEYPAD.

### **ABBREVIATIONS**

ABOVE COUNTER ABOVE FINISHED FLOOR ABOVE GRADE AMERICAN WIRE GAUGE FIRE ALARM

FURNISHED BY OTHERS INSTALLED BY CONTRACTOR

GROUND FAULT CIRCUIT INTERRUPTER

HORSEPOWER ISOLATED GROUND JUNCTION BOX

NOT IN CONTRACT

NIGHT LIGHT, FIXTURE NOT SWITCHED

RACEWAY ONLY

RECEPTACLE **SPECIFICATIONS** 

TELEPHONE TERMINAL BOARD (TTB)

UNLESS NOTED OTHERWISE

**WEATHERPROOF** 

EXISTING TO REMAIN EXISTING TO BE REMOVED

EXISTING TO BE RELOCATED

#### FIXTURE SCHEDULE

FS1 2' X 4' FLUORESCENT SURFACE MOUNTED FIXTURE, DIE-FORMED STEEL HOUSING, BAKED WHITE ENAMEL FINISH, ACRYLIC PRISMATIC LENS, TWO BALLASTS. METALUX 2M332A SERIES, DAY-BRITE OR WILLIAMS. LAMPS,3-F32/T8/3500K. INPUT

FSIE SAME AS FSI EXCEPT WITH EMERGENCY BATTERY BALLAST. METALUX 2M332A SERIES, DAY-BRITE OR VILLIAMS. LAMPS,3-F32/T8/3500K. INPUT WATTS - 87.

FS2 FLUORESCENT SURFACE MOUNTED FIXTURE, DIE-CAST ALUMINUM HOUSING, DARK BRONZE FINISH, PRISMATIC POLYCARBONATE REFRACTOR, FULLY SEALED AND GASKETED. LUMARK PLVR SERIES OR APPROVED. LAMPS, 2-28V/COMPACT FLUORESCENT.

FS3 1' X 4' FLUDRESCENT SURFACE MOUNTED FIXTURE, DIE-FORMED STEEL HOUSING, BAKED WHITE ENAMEL FINISH, ACRYLIC PRISMATIC LENS. METALUX MC-232A SERIES, DAY-BRITE OR VILLIAMS. LAMPS,2-F32/T8/3500K. INPUT WATTS - 57.

FS3E SAME AS FS3 EXCEPT WITH EMERGENCY BATTERY BALLAST.
METALUX MC-232A SERIES, DAY-BRITE OR VILLIAMS. LAMPS;2-F32/T8/3500K. INPUT WATTS - 57.

FS4 FLUGRESCENT SURFACE MOUNTED FIXTURE, 18' DIAMETER OPAL ACRYLIC BOWL, BRUSHED ALUMINUM TRIM RING. ADVENT AC2020 SERIES OR APPROVED. LAMPS;1-38W/COMPACT FLUDRESCENT. INPUT WATTS - 37.

FP1 FLUCRESCENT PENDANT MOUNTED FIXTURE, 24" DIAMETER CIPAL ACRYLIC BOVL, BRUSHED ALUMINUM TRIM RING. ADVENT AP1015 SERIES OR APPROVED. LAMPS,1-39W/BIAX/3500K. INPUT WATTS - 43.

FR1 FLUDRESCENT RECESSED BAFFLED DOWNLIGHT, 7" NOMINAL APERTURE, SPECULAR PARABULIC CRUSS BAFFLE, FLANGE TO MATCH CEILING TYPE. EDISON PRICE BAFLUX/7 SERIES, CAPRI OR HALO. LAMPS,2-9V/TT/3500K. INPUT WATTS - 21.

EX FLUORESCENT POLYCARBONATE EXIT FIXTURE, LEAD ACID BATTERY, SINGLE OR DOUBLE FACED, WHITE HOUSING FINISH, GREEN LETTERS, WITH ARROWS AS INDICATED ON DRAWINGS. SURE-LITES CCX-4 SERIES, EMERGILITE OR DUAL-LITE. LAMPS,2-5W/PL. INPUT WATTS - 16.

#### GENERAL FIXTURE NOTES:

PROVIDE FIRE BONNETS FOR ALL RECESSED FIXTURES MOUNTED IN FIRE RATED CEILINGS.

2. ALL FLUORESCENT BALLAST'S SHALL BE ELECTRONIC.

EMERGENCY BATTERY BALLAST'S SHALL BE IDTA 180 DR APPROVED EQUAL. PROVIDE ADDITIONAL CONDUCTORS FOR AN UNSWITCHED SOURCE OF POWER.

4. PROVIDE ALL MOUNTING HARDWARE, FLANGES, STEMS, SLOPE CEILING ADAPTERS, SWIVEL HANGERS, ETC. FOR THE CEILING

5. VERIFY SUPPLY VOLTAGE FOR ALL FIXTURES WITH DRAWINGS.

# GENERAL NOTES

1. THE CONTRACTOR SHALL NOT SCALE ELECTRICAL DRAWINGS. REFER TO ARCHITECTURAL DRAWINGS FOR ALL DIMENSIONS AND EXACT LOCATIONS.

2. BEFORE SUBMITTING A BID, THE CONTRACTOR MUST VISIT SITE AND REVIEW THE CONDITIONS THAT AFFECT THE WORK SHOWN. THE EXISTING CONDITIONS ARE BASED ON DRAWINGS BY OTHERS AND CASUAL FIELD OBSERVATION. ALTHOUGH THIS INFORMATION IS BELIEVED TO BE RELIABLE, THE ENGINEER IS NOT RESPONSIBLE FOR ITS ACCURACY.

3. CONTRACTOR IS RESPONSIBLE FOR CORE DRILLING, CUTTING, PATCHING, FIRE STOPPING, ETC. AS REQUIRED.

4. POWER OUTAGES MUST BE APPROVED IN WRITING BY THE OWNER AT LEAST TWO DAYS PRIOR TO THE OUTAGE. THE OWNER SHALL DICTATE TO THE CONTRACTOR ALL TIME WINDOWS AVAILABLE FOR SUCH OUTAGES.

5. CONTRACTOR IS RESPONSIBLE FOR LOCATING ALL EXISTING CIRCUITS AND WIRING FOR EXISTING DEVICES AND EQUIPMENT TO REMAIN. ALL CIRCUITS, SWITCHING, ETC. THAT IS IN OR PASSES THROUGH THE CONSTRUCTION AREA AND SERVES AREAS OUTSIDE THE CONSTRUCTION AREA MUST BE MAINTAINED OR MODIFIED AS

6. THE DRAWINGS ARE DIAGRAMMATIC AND DO NOT SHOW EXACT DETAILS. INCLUDE LABOR AND MATERIALS REQUIRED TO COMPLETE THE WORK INDICATED.

WORK OF OTHER TRADES AND EXISTING CONDITIONS: THE ELECTRICAL DRAWINGS DO NOT SHOW COMPLETE DETAILS OF THE BUILDING CONSTRUCTION. REFER TO THE DRAWINGS OF OTHER DISCIPLINES FOR DETAILS WHICH MAY AFFECT THE EXECUTION OF THIS WORK. FIELD VERIFY EXISTING CONDITIONS PRIOR TO COMMENCEMENT OF WORK.

#### **ENERGY BUDGET CALCULATION**

1994 Washington State Nonresidential Energy Code Compliance Form

Lighting Summary LTG-SUM Project Info Central Area Senior Center Date: March 27, 1998 500 30th Ave. South Seattle, WA 98144 Applicant Name: Path Engineers, Inc. Contact: Carl Maehl Applicant Address: 17928 Bothell-Evt Hwy S.E., Ste H, Bothell, WA 98012 pplicant Phone: (425) 481-7735

Project Description ☐ Addition ☒ Alteration \_\_ New Building ☐ Lighting Power Allowance ☐ Systems Analysis Compliance Option (See Qualification Checklist, Indicate Prescriptive & LPA spaces clearly on plans.) Alteration Exceptions No changes are being made to the lighting

Less than 60% of the fixtures are new, and installed lighting wattage is not being increase Maximum Allowed Lighting Wattage (Interior)

Location		Allowed		Allowed
(floor/room		Watts per	Area in S.F.	by
number)	Occupancy Description	square foot		Area
101	Dining Room	1.5	2224	3336
102	Corridor	1.2	1088	1305.0
103	Reception	1.2	309	370.8
104	Solarium	1	758	758
			·	
From Table 15—1	- including all exceptions taken from footnotes.		Total Allowed Vetts	5770.4

Proposed Lighting Wattage (Interior) ('May not exceed Total Watts for Interior) Number of Fixture Description FS1 - 2X4 SURFACE MTD, 3 LAMP FS1E - 2X4 3 LAMP, EMER BALLAST FR1 - RECESSED CAN LT FS3 - 1X4 SURFACE MTD, 2 LAMP FS3E - 1X4 2 LAMP, EMER BALLAST FP1 - FLUORESCENT PENDANT FS4 - FLUORESCENT SURF. MOUNTED

Total Proposed Watts may not exceed Total Allowed Watts for Interior

Maximum	Allowed Lighting Wattage (Exterior)			
Location	Description	Allowed watts per ft2 or per if	Area in ft2 or if for perimeter	Allowed watts
Covered Parking		0.2 W/ft2		
Open Parking		0.2 W/ft2		
Outdoor Areas		0.2 W/ft2		
Bldg.(by facade)		0.25 W/ft2		
Bldg.(by perim)	Bldg Perimeter	7.5 W/If	450	337
Note: for building	exterior, choose either the facade area or the perimeter method,	but not both)	Total Allowed Watts	337

Proposed Lighting Wattage (Exterior) ('May not exceed Total Watts for Exterior Fixture Description FS2 - FLUORESCENT SURF MTD 3ldg Mounted Total Proposed Watts may not exceed Total Allowed Watts for Exterior.

Prescriptive Spaces | Occupancy | Qualification Checklist | Lighting Fixtu ☐ Warehouses, storage areas or aircraft storage hangers ☐ Other Check here if at least 95% of the fixtures in the space meet all four criteria: 1. Fixtures are fluorescent, non-lensed, with only one or two lamps, and Note: If accupancy type is "other" and fixture 2. Lamps are T-5, T-6, T-8 or PL, and onewer is checked, the number of flutures in 3. Lamps are 5-50 Watts, and he apace is not limited by Code. Clearly 4. Ballasts are electronic ballasts ndicate these spaces on plane. If not ualified, do LPA Calculations


NOTE: This form is intended for energy code compliance purposes only. The contractors is still responsible for establishing the exact number of each type of fixture on this project. This form shall not be utilized for such purposes.

#### **ELECTRICAL DRAWING INDEX**

ELECTRICAL SYMBOLS & ABBREVIATIONS **ELECTRICAL DEMOLITION PLAN** 

LIGHTING PLAN

POWER PLAN ONE-LINE DIAGRAM

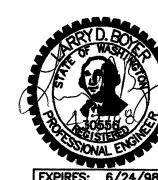

CONTACT: CARL MAEHL

JOB NUMBER: 7134

17928 BOTHELL EVERETT HWY SE, SUITE H BOTHELL, WASHINGTON 98012 \*\*NGINEERS INC. (425) 481-7735 FAX (425) 481-7692

DONALD HING ARCHITECTS 2107 Elliott Avenue Suite 305

Seattle, WA 98121 PHONE (206) 443-9939 FAX (206) 443-9891

# CENTRAL AREA SENIOR CENTER

500 30th Avenue South Seattle, WA 98144


CONSTRUCTION **DOCUMENTS** 4/7/98


**ELECTRICAL** SYMBOLS & **ABBREVIATIONS** 

REVISIONS

DATE DESCRIPTION

S H E E T

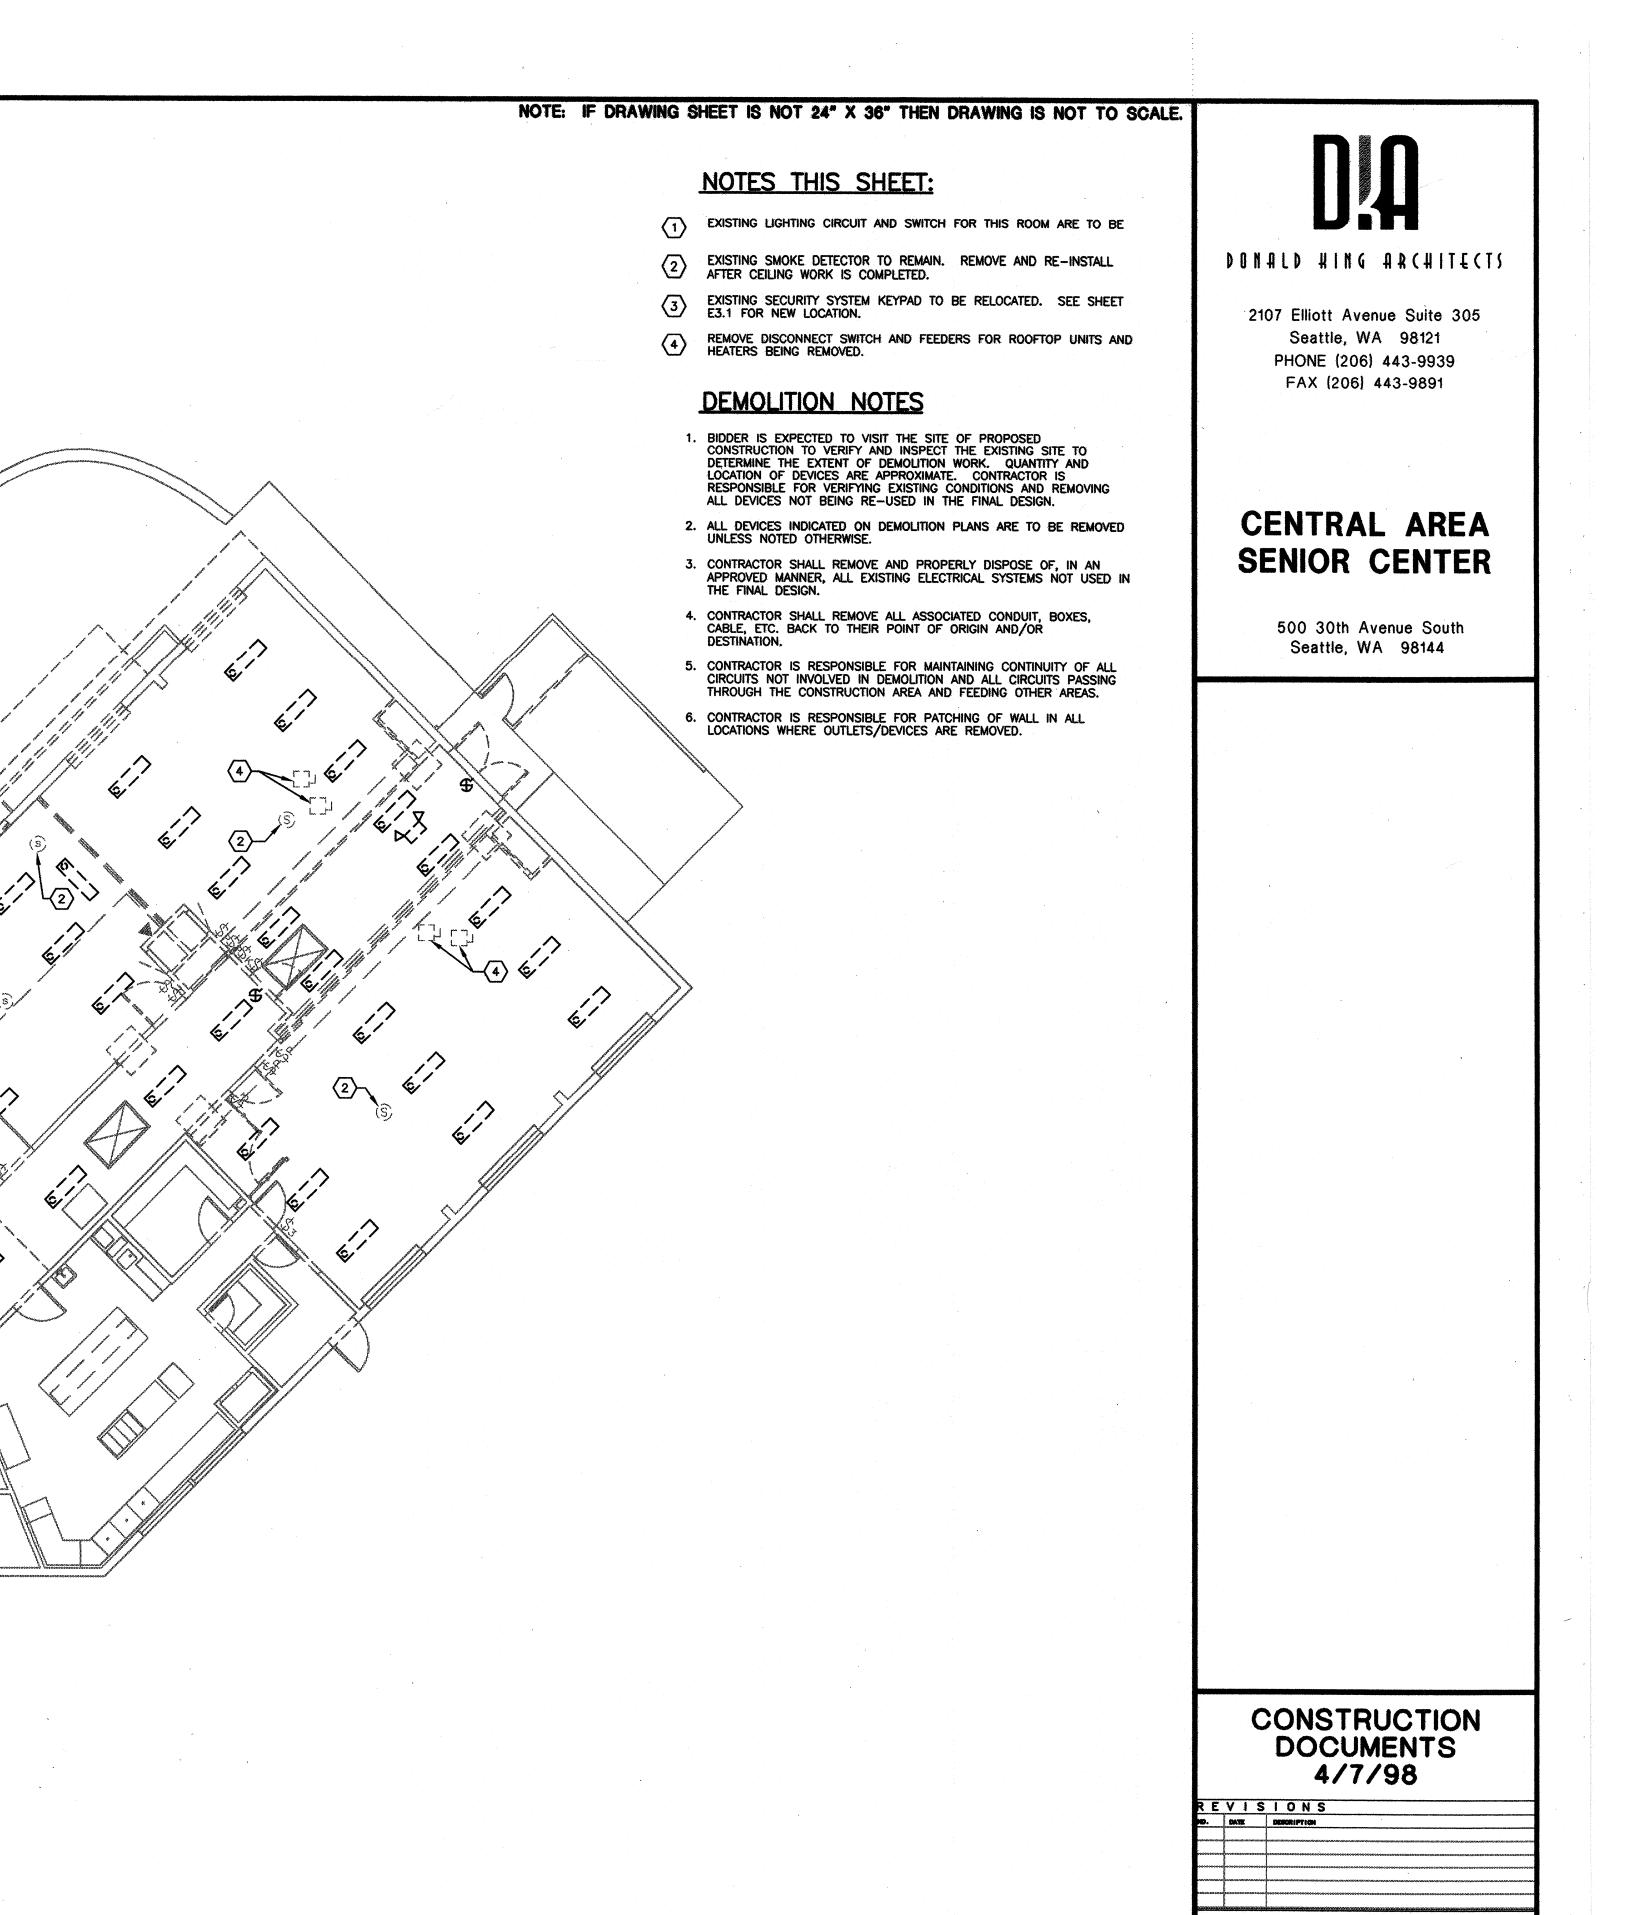

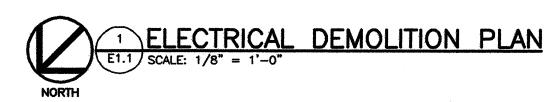

page accord accord accord process business current process income page.



179 BOT INGINEERS INC. (42)

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CONTACT: CARL MAEHL JOB NUMBER: 7134 E1.1

ELECTRICAL

DEMOLITION

PLAN

## NOTE: IF DRAWING SHEET IS NOT 24" X 36" THEN DRAWING IS NOT TO SCALE.

## NOTES THIS SHEET:

- EXISTING LIGHTING FIXTURE. EXTEND EXISTING LIGHTING CIRCUIT TO NEW SWITCH.
- NEW LIGHTING FIXTURES IN THIS ROOM ARE TO BE MOUNTED IN SAME LOCATION AS FIXTURES BEING REMOVED. EXISTING LIGHTING CIRCUIT AND SWITCH ARE TO BE RE-USED.
- (3) FIXTURE TO BE CONTROLLED BY NEW PHOTO ELECTRIC CELL.

CONTACT: CARL MAEHL JOB NUMBER: 7134



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# CENTRAL AREA SENIOR CENTER

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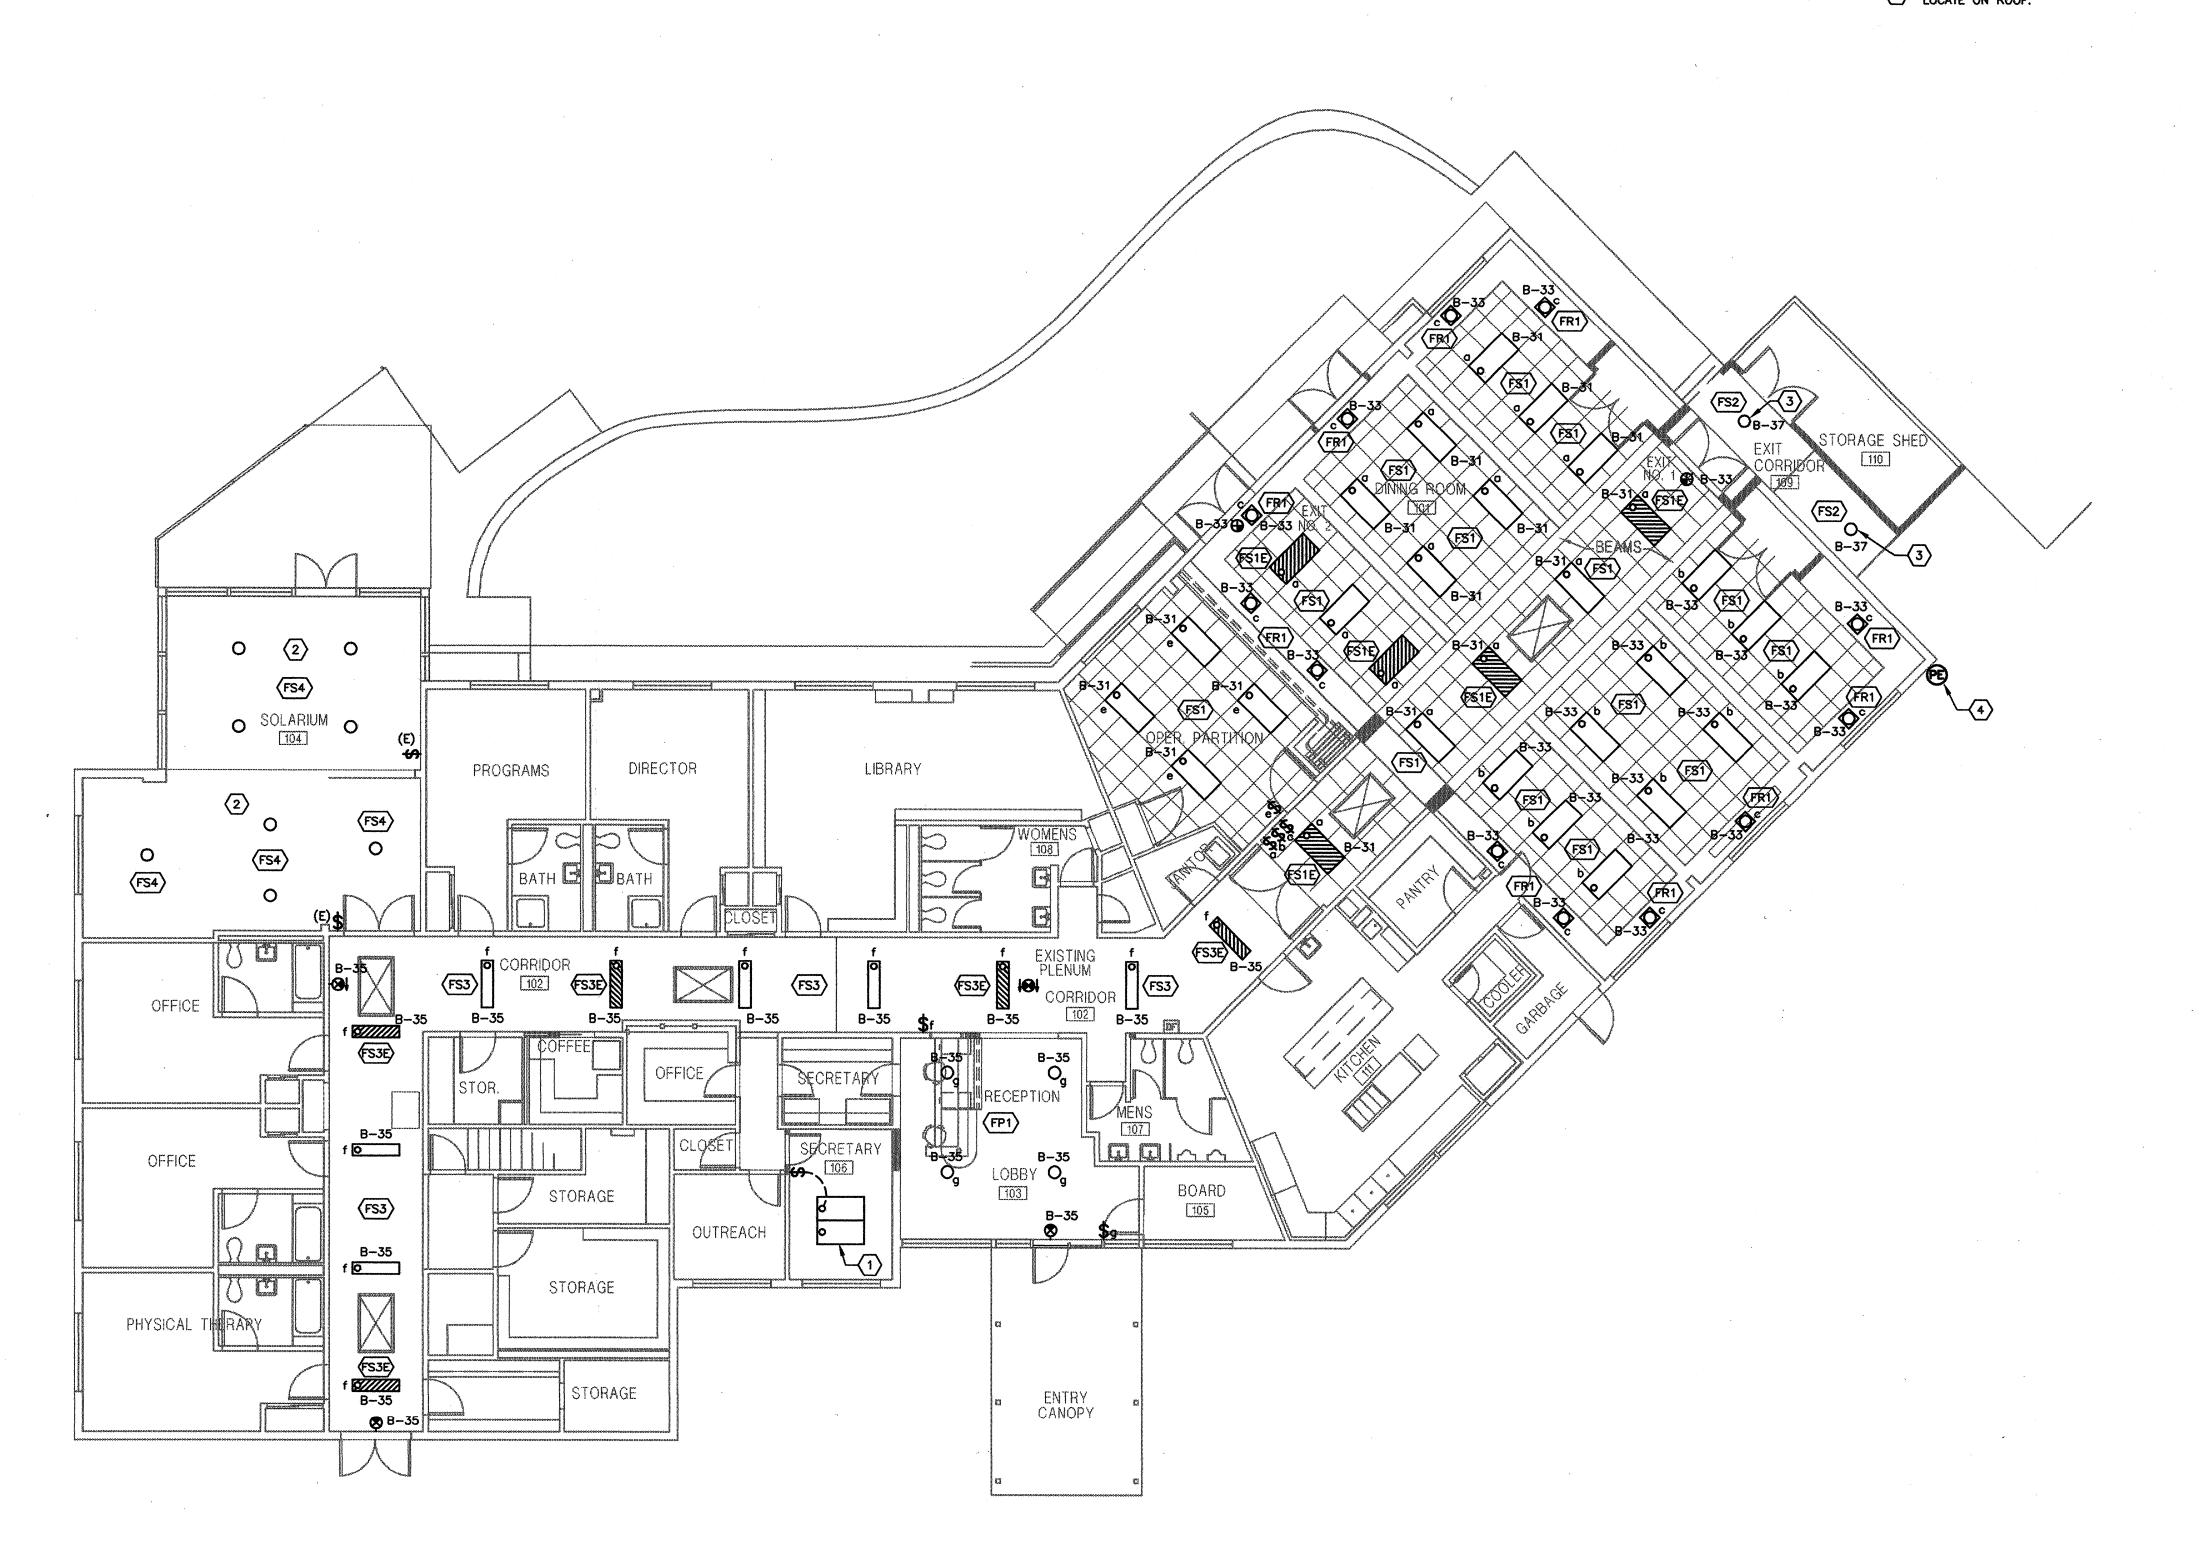
# CONSTRUCTION DOCUMENTS 4/7/98


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10.	DATE	DESCRIPTION
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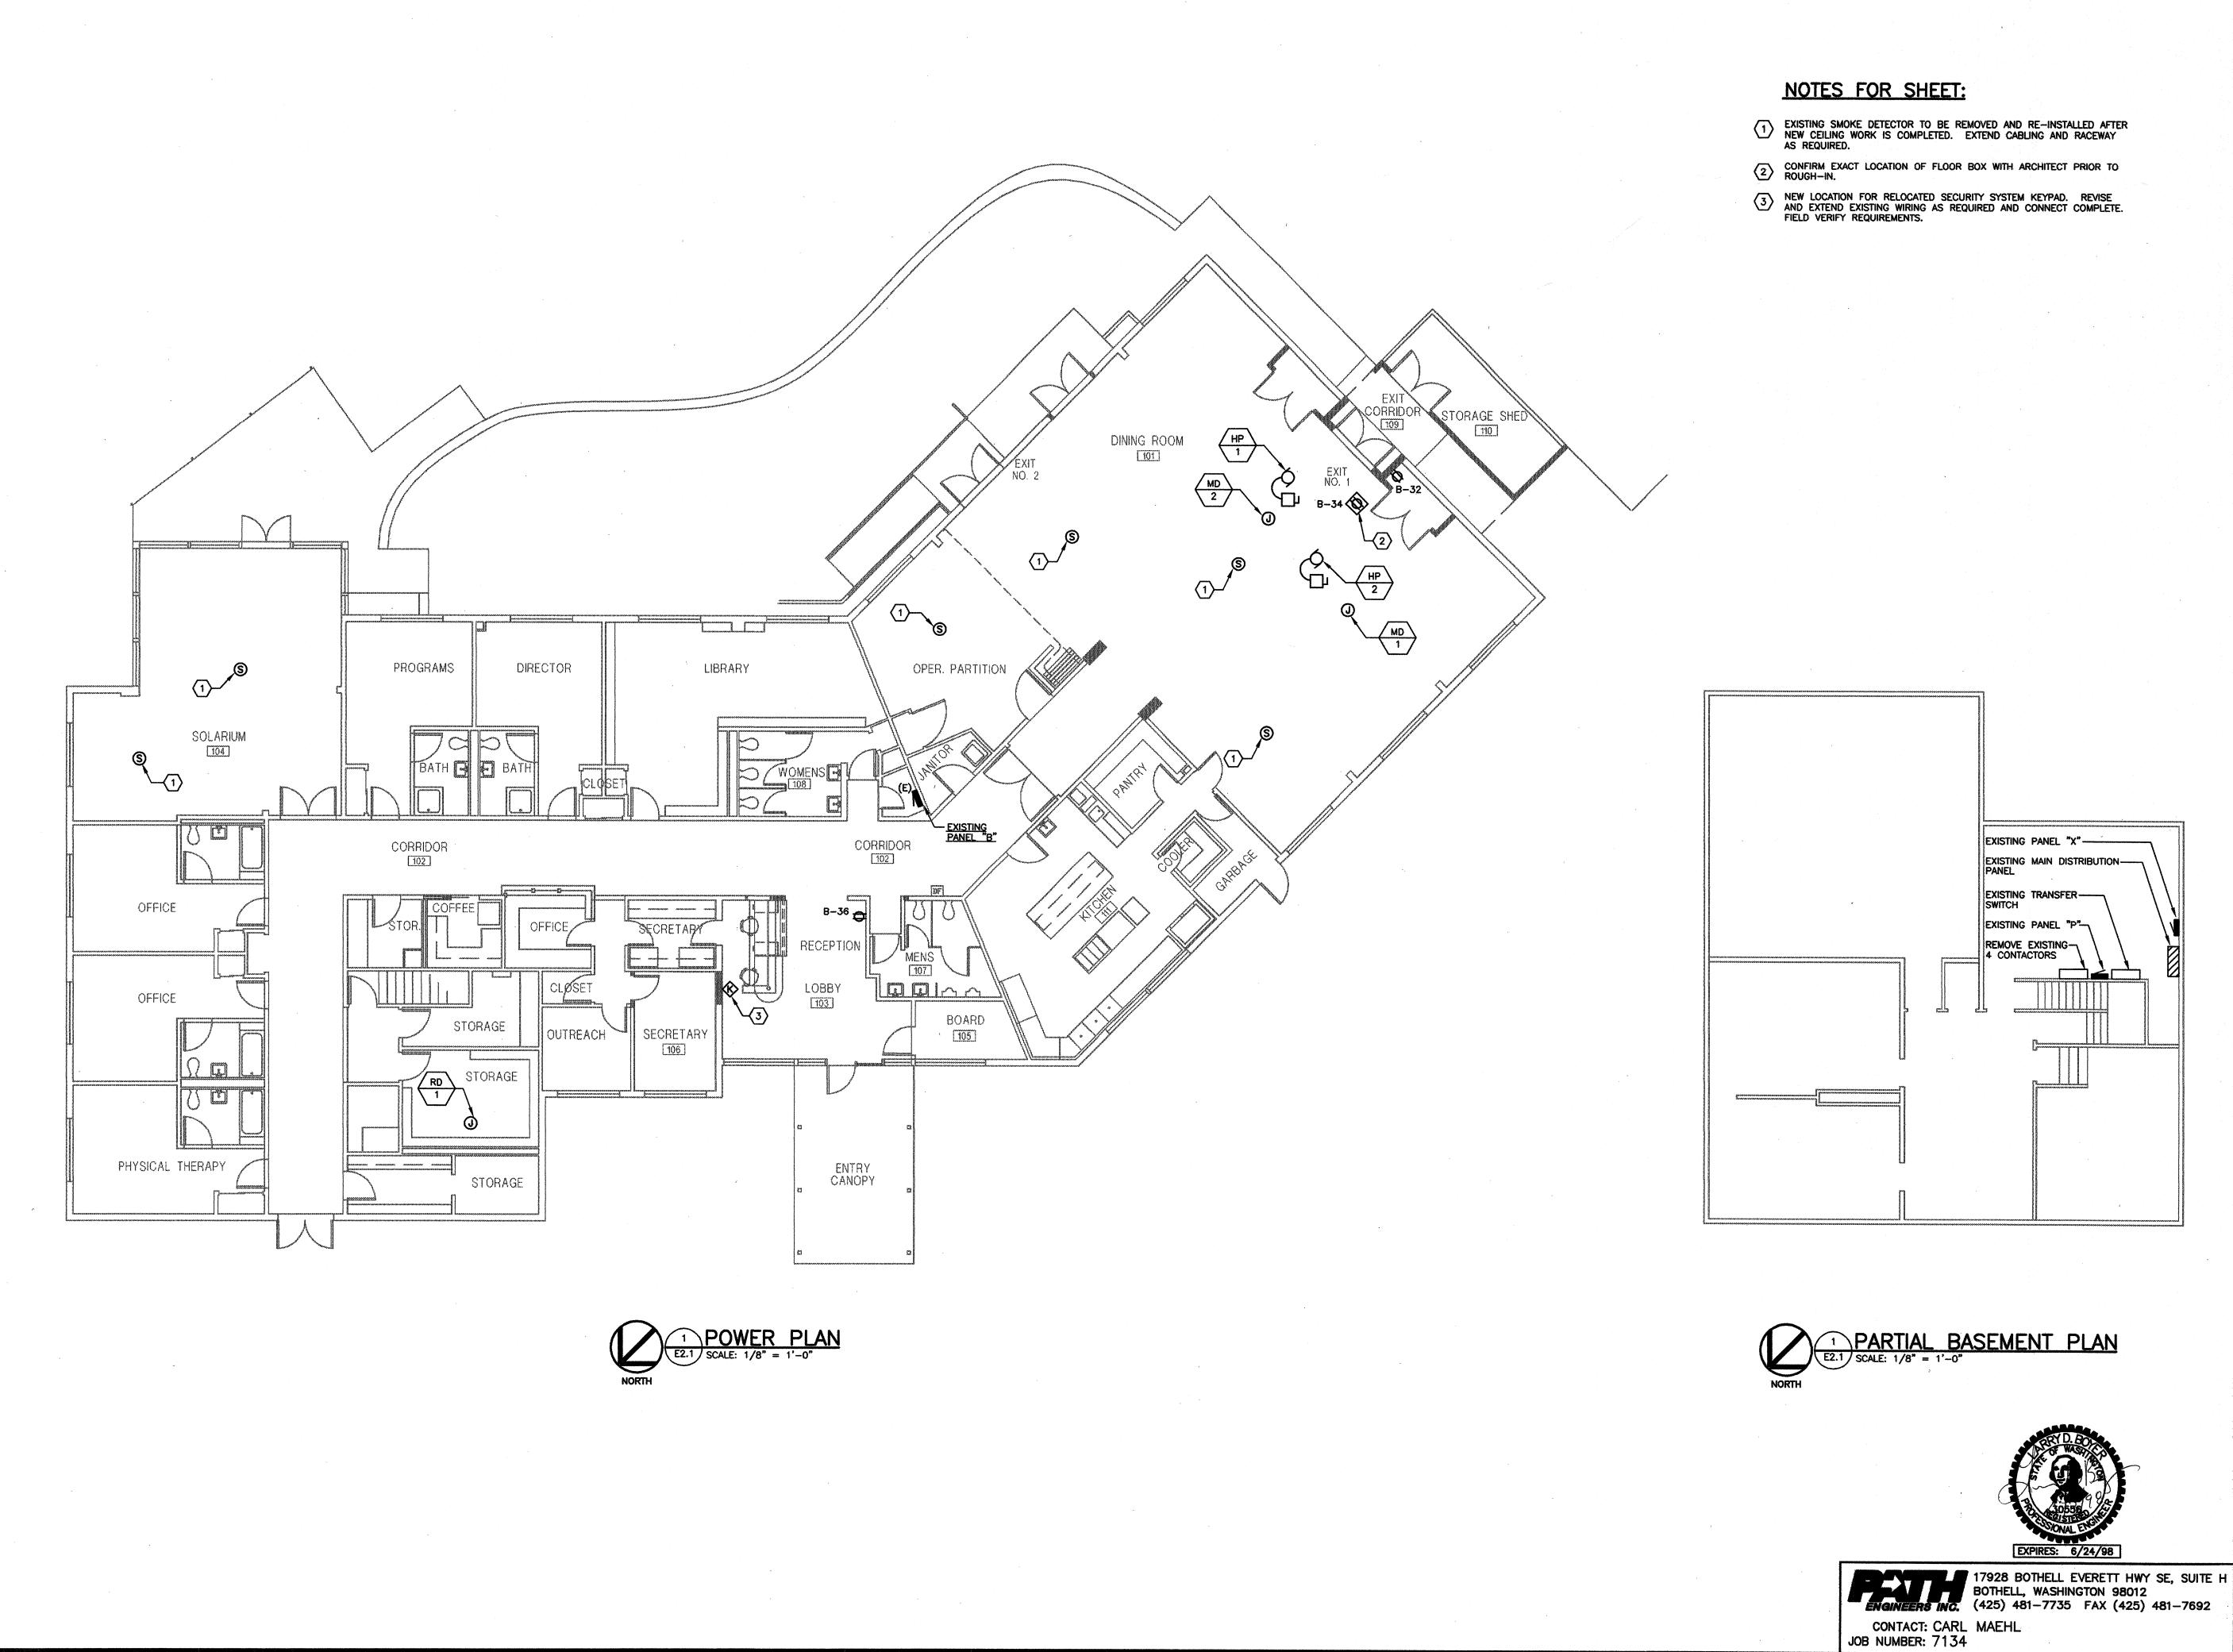
## LIGHTING PLAN

DRAWN: CM/GB
CHECKED: LDB
PROJECT NO.: 7134

S H E E T 17928 BOTHELL EVERETT HWY SE, SUITE H
BOTHELL, WASHINGTON 98012
(425) 481-7735 FAX (425) 481-7692





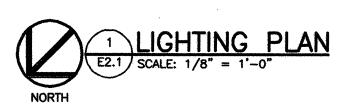

NOTE: IF DRAWING SHEET IS NOT 24" X 36" THEN DRAWING IS NOT TO SCALE.

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# CENTRAL AREA SENIOR CENTER

500 30th Avenue South Seattle, WA 98144

CONSTRUCTION DOCUMENTS 4/7/98

REVISIONS

**POWER** PLAN

S H E E

E3.1

#### **CONNECTED LOADS:**

LIGHTING, NEW AND EXIST	NG		18.6	KVA
RECEPTACLES			1 <b>3.</b> 7	KVA
DRYER AND WASHER			6.5	KVA
KITCHEN EQUIPMENT			56. <del>9</del>	KVA
HEATING			15.0	KVA
MOTORS			19.7	KVA
	TOTAL	=	130.4	KVA

DESCRIPTION	LOCATION				Ţ	<del></del>	<del></del>	<del></del>	
	LOCATION	CIRCUIT	PH.	WIRE	VOLTAGE	AMPS	KW	нР	NOTES
PUMP	ROOF	P-1,3,5	3	4	208	53.4 MCA			1,15
PUMP	ROOF	P-2,4,6	3	4	208	53.4 MCA			1,15
RIZED DAMPER	ROOF	8-38	1	12	120		0.1		3,15
RIZED DAMPER	ROOF	B-38	1	12	120		0.1		3,15
GERATED AIR DRYER	STORAGE ROOM	B-38	1	12	120		0.27		3
	PUMP  RIZED DAMPER  RIZED DAMPER	PUMP ROOF  RIZED DAMPER ROOF  RIZED DAMPER ROOF	PUMP         ROOF         P-2,4,6           RIZED DAMPER         ROOF         B-38           RIZED DAMPER         ROOF         B-38	PUMP         ROOF         P-2,4,6         3           RIZED DAMPER         ROOF         B-38         1           RIZED DAMPER         ROOF         B-38         1	PUMP         ROOF         P-2,4,6         3         4           RIZED DAMPER         ROOF         B-38         1         12           RIZED DAMPER         ROOF         B-38         1         12	PUMP         ROOF         P-2,4,6         3         4         208           RIZED DAMPER         ROOF         B-38         1         12         120           RIZED DAMPER         ROOF         B-38         1         12         120	PUMP         ROOF         P-2,4,6         3         4         208         53.4 MCA           RIZED DAMPER         ROOF         B-38         1         12         120           RIZED DAMPER         ROOF         B-38         1         12         120	PUMP ROOF P-2,4,6 3 4 208 53.4 MCA  RIZED DAMPER ROOF B-38 1 12 120 0.1  RIZED DAMPER ROOF B-38 1 12 120 0.1	PUMP ROOF P-2,4,6 3 4 208 53.4 MCA  RIZED DAMPER ROOF B-38 1 12 120 0.1  RIZED DAMPER ROOF B-38 1 12 120 0.1

SEE MECHANICAL DRAWINGS FOR LOCATIONS OF ALL MECHANICAL EQUIPMENT.

F.B.M.C. = FURNISHED BY MECH. CONTRACTOR F.B.O. = FURNISHED BY OWNER

9. CONTROL DEVICE F.B.O. I.B.E.C.

I.B.E.C. - INSTALLED BY ELECTRICAL CONTRACTOR.

SCHEDULE NOTES:

1. NON FUSED DISCONNECT 2. FUSED DISCONNECT

10. VARIABLE FREQUENCY DRIVE 3. H.P. RATED SWITCH 11. SWITCH WITH ROOM LIGHTS 4. TOGGLE SWITCH 12. LOW VOLTAGE CONTROL BY OTHERS 13. LOCATE CONTROL ADJACENT TO ROOM SWITCH 5. MANUAL STARTER

6. MAGNETIC STARTER 14. NEMA 1 15. NEMA 3R

7.	STARTER F.B.O. I.B.E.C.	
8.	DISCONNECT F.B.O. I.B.E.C.	


SPACE

SPACE

1 SECTION	VOLT / 3 PHASE / 4 WI N: SINGLE LUGS	MOUNTING: SURFACE							
LOAD VA	SERVES	WIRE	C.B.	CKT PH	CKT	C.B.	WIRE	SERVES	LOAD V
	EXISTING		20/1	1 •	2	20/1		EXISTING	
	EXISTING		20/1	3 0	4			EXISTING	
	EXISTING		20/1	5	° 6			EXISTING	1
	EXISTING		20/1	7 •	8	20/1		EXISTING	
	EXISTING		20/1	g .	10	20/1		EXISTING	
	EXISTING		20/1	11	• 12			EXISTING	
	EXISTING		20/1	13 •	14	20/1	:	EXISTING	
<u>-</u>	EXISTING		20/1	15 •	16	20/1		EXISTING	
	EXISTING		20/1	17	• 18	20/1		EXISTING	
	EXISTING		/3	19 -	20	0/3		EXISTING	
			<del></del>	21 0	22				-]
			Ī	2.3	• 24				
	EXISTING		/3	25 •	26	20/1		EXISTING	
				27 .	28	20/1		EXISTING	
				29	• 30	20/1		EXISTING	
1535	LTG DINING ROOM		20/1	31 .	32	20/1		REC DINING ROOM	180
1220	LTG DINING ROOM		20/1	33 •	34	20/1		FLOOR BOX REC DINING	180
800	LTG CORRIDOR		20/1	35	• 36	20/1		REC RECEPTION	180
110	EXTERIOR LTG		20/1	37 -	38			MD-1,MD-2,RD-1	470
	SPACE		1	39 •	40			SPACE	
	SPACE			41	• 42			SPACE	1

	EXISTING LIGHTING CLASS PANELBOARD P										
	208/120 1 SECTION	VOLT / 3 PHASE / 4 WIRE H: SINGLE LUGS	125 AMP MEO					MOUNTING: SURFACE			
	LOAD VA	SERVES	WIRE	C.B.	СКТ	PH	CKT	C.B.	WIRE	SERVES	LOAD VA
**	19200	HP-1		60/3	1 4	,	2	60/3		HP-2	19200
					3	ø	4				
					5	•	6				
		SPARE		50/3	7 •	)	8	50/3		SPARE	
					9	٥	10				
					11	-	12				

\*\* - DENOTES PROVIDE NEW CIRCUIT BREAKER SIZED AS INDICATED

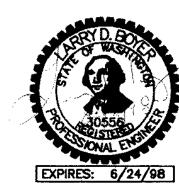

17928 BOTHELL EVERETT HWY SE, SUITE H
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DONALD WING ARCHITECTS

CENTRAL AREA SENIOR CENTER

> 500 30th Avenue South Seattle, WA 98144

DRAWN: CM/GB CHECKED: LDB PROJECT NO.: 7134 S H E E

CONSTRUCTION DOCUMENTS 4/7/98

REVISIONS

ONE-LINE

DIAGRAM

ONE-LINE DIAGRAM

1. EXISTING EQUIPMENT IS SHOWN DASHED.

EXISTING PANEL "B"

EXISTING PANEL "C"

EXISTING PANEL "P"

EXISTING H.W. TANK

EXISTING UNDERGROUND SERVICE
2 SETS OF 3°C, -(4) #300 MCM CU.

r-----

EXISTING PANEL "X"

EXISTING PANEL "K"

EXISTING PANEL A


#### HEAT PUMP SCHEDULE NET COOLING\* CAP. @ 95°F COP\* NET HEATING\* @ 47°F CAP. @ 17°F NET HEATING\* CAP. @ 47°F COP\* @ 17°F HSPF HEATER SOUND RATINGS ELECTRIC WEIGHT LBS. NOMINAL VOLTAGE MODEL CFM SEER\* MCA HEAT FLA TONS BTUH BTUH (BELS) BTUH BTUH BTUH KW CARRIER 20.8 27.4 47,500 12.0 44,000 2.0 7.0 208V-3ø 7.5 1600 3.5 23,600 8.2 411 50HX048 / HP ` CARRIER 1600 47,500 12.0 44,000 3.5 2.0 7.0 208V-3ø 7.5 27.4 23,600 8.2 411 20.8 50HX048

\*RATED IN ACCORDANCE WITH ARI STANDARD 210/240, LATEST REVISION AND/OR U.S. GOVERNMENT DOE TEST PROCEDURES. \*\*RATED IN ACCORDANCE WITH ARI STANDARD 270, LATEST REVISION.

AIR DEVICE SCHEDULE									
DEVICE NO.	AIR QTY (CFM)	BORDER TYPE	NECK SIZE	FACE SIZE	TITUS MODEL NO.	NOTES			
A	270	1	9X9	14X14	TDC	2.,3.			

- 1. PERFORATED PLATE FACE, WITH SEISMIC CLIPS.
- 2. PROVIDE OPPOSED BLADE VOLUME CONTROL DAMPER. 3. PROVIDE OFF-WHITE FINISH FOR FACE PLATES, FRAME, AND
- LOUVER BARS.
- 4. PROVIDE ROUND TO SQUARE ADAPTER AT DIFFUSER NECK.
- 5. PROVIDE OFF-WHITE FINISH FROM FRAME AND FACE PLATE, FLAT BLACK FOR EXPOSED TO VIEW INTERNAL PARTS.

REFRIGERATED COMPRESSED AIR DRYER									
250 PSIG MAX PRESSURE, EPA APPROVED, SMOOTH NON-FOULING HEAT EXCHANGER TUBES, PRECOOLER, REHEATER, UL AND CSA APPROVED, 99.9% EFFICIENT SEPERATOR, AUTO CONDENSATE DRAIN.									
DEVICE NO.	MAX AIR COMPRESSOR HP	CAPACIT PRESSI POI 35°F	JŘE DEW	INPUT KW	VOLTAGE	INLET, OUTLET CONNECTION	REFRIGERANT	MODEL	
RD 1	ЗНР	10	13	0.27	115-1ø	1/2"OD	R134A	INGERSOLL—RAND DXR—10 OR EQUAL	

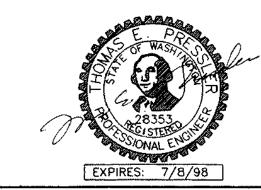

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JOB NUMBER: 7134

DONALD HING ARCHITECTS

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# CENTRAL AREA SENIOR CENTER


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CONSTRUCTION DOCUMENTS 4/7/98

REVISIONS

HVAC SCHEDULES

DRAWN: DRA CHECKED: TEP PROJECT NO.: 7134 S H E E T



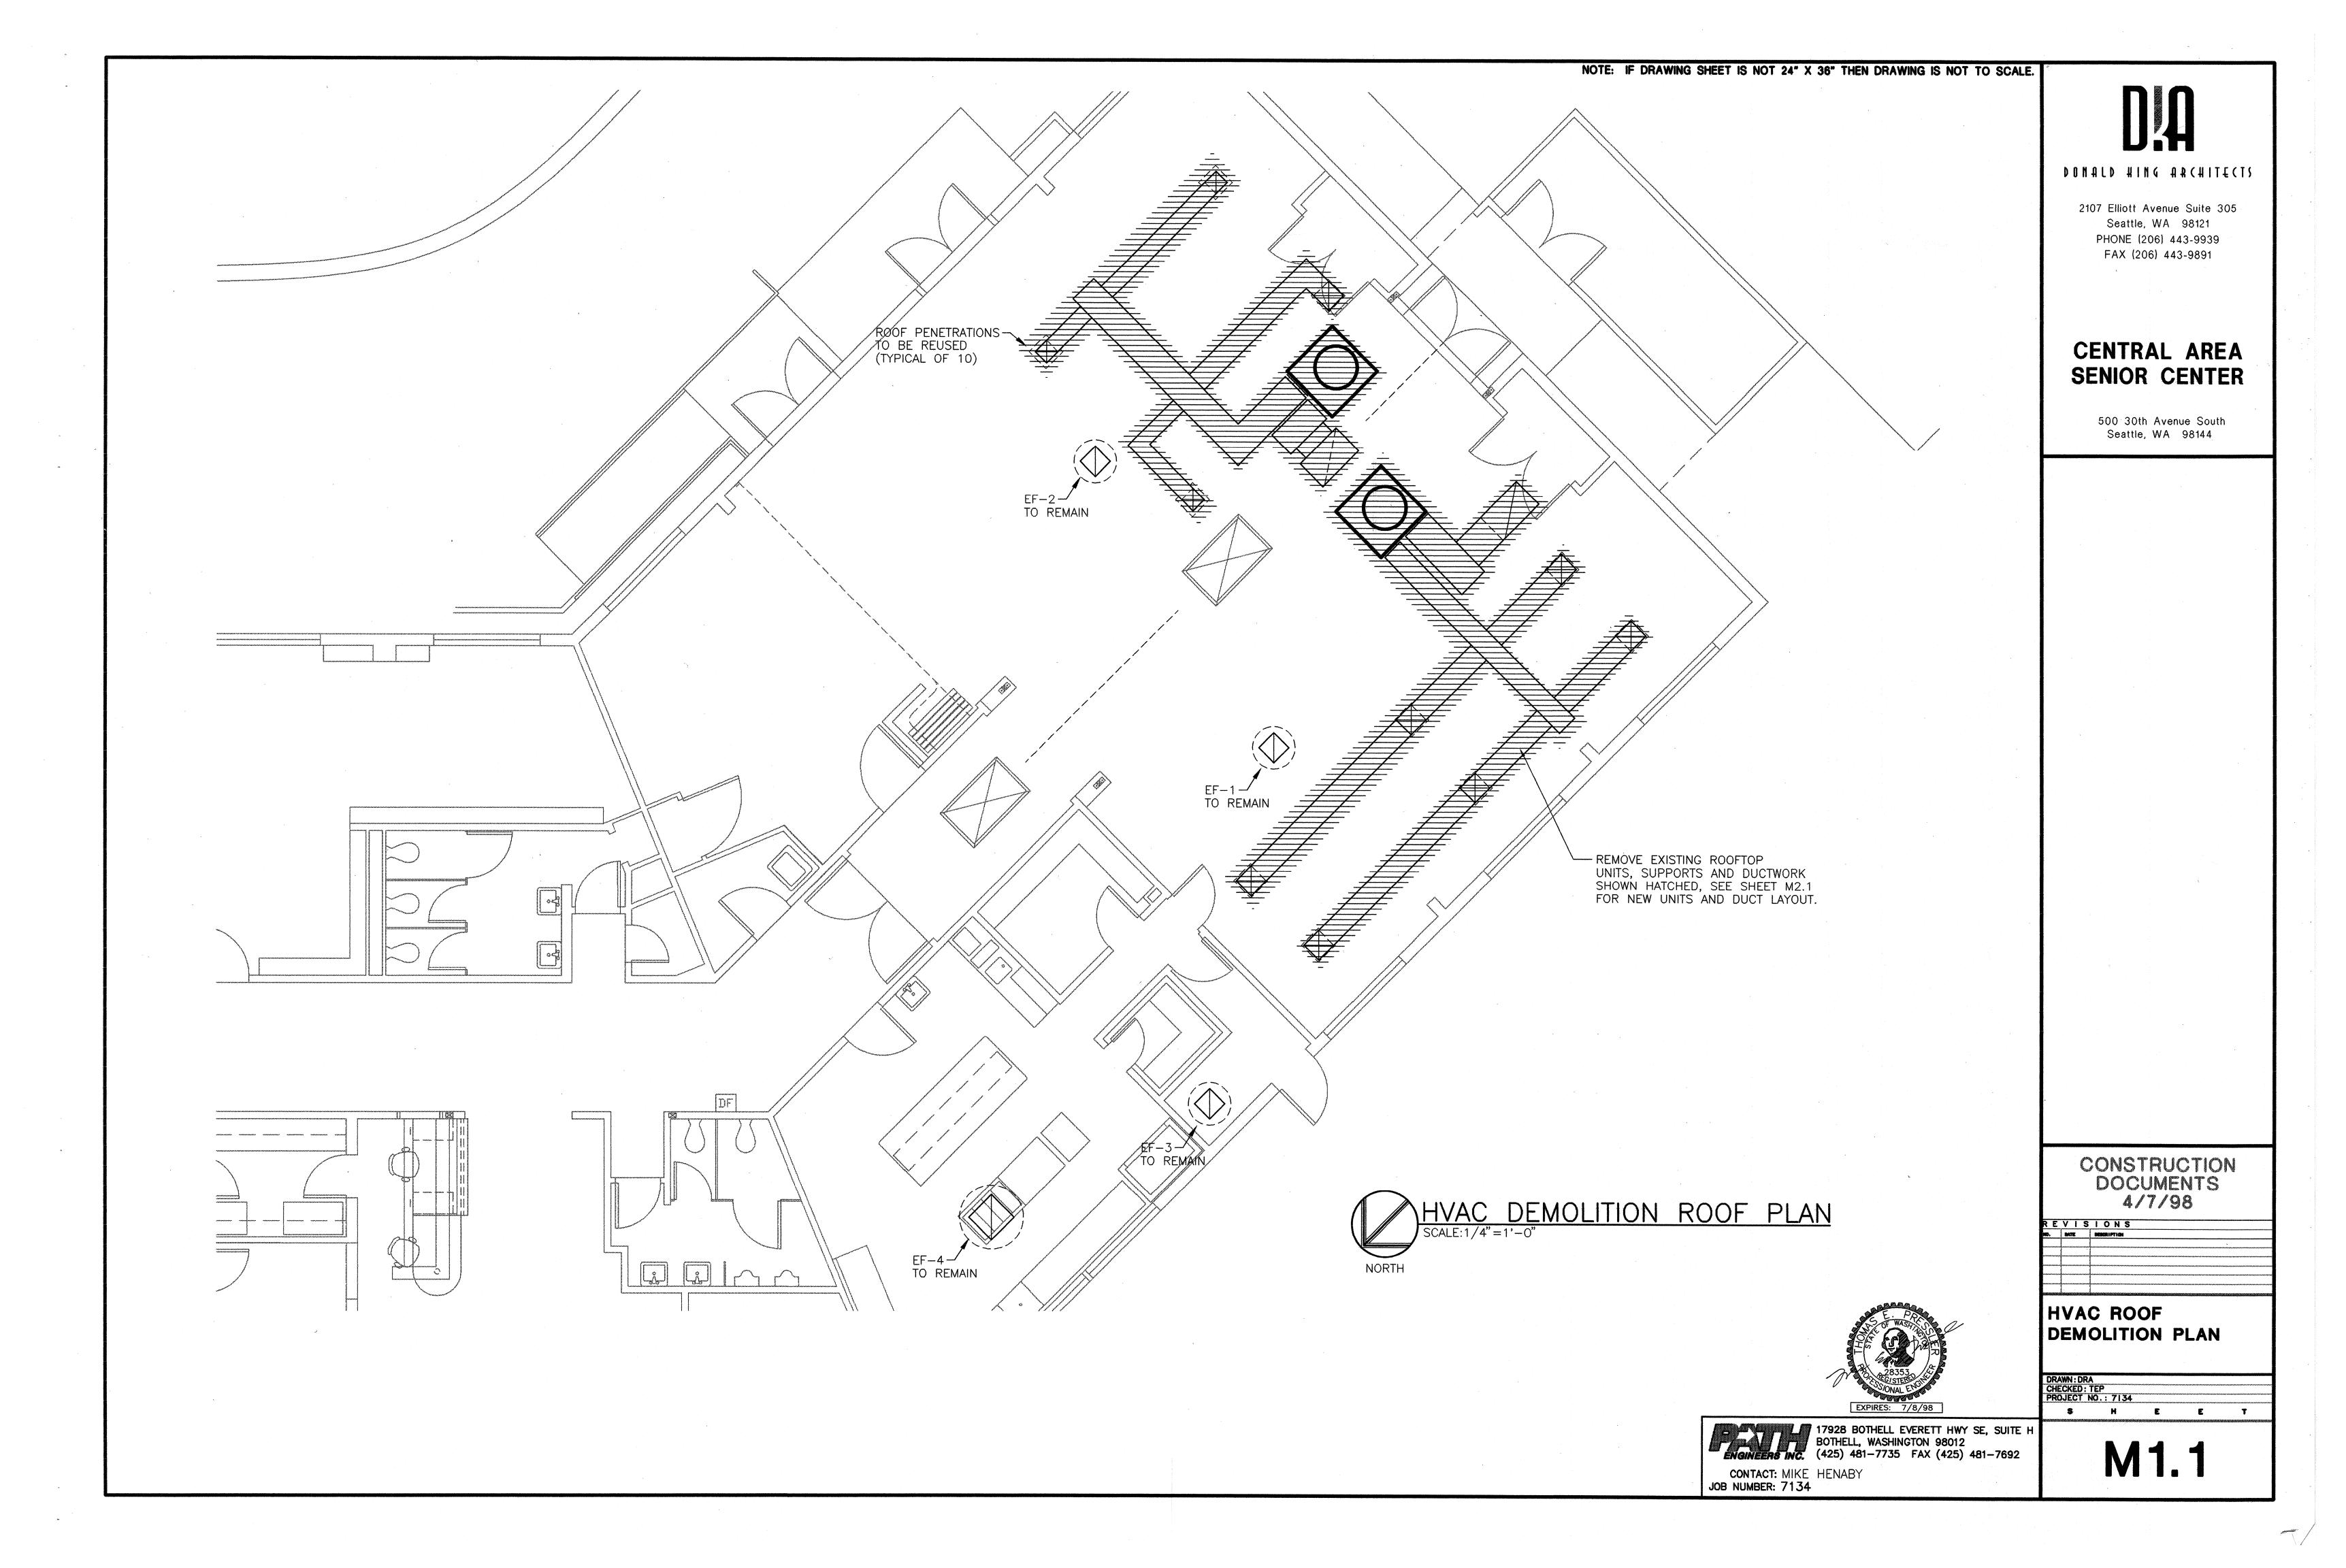

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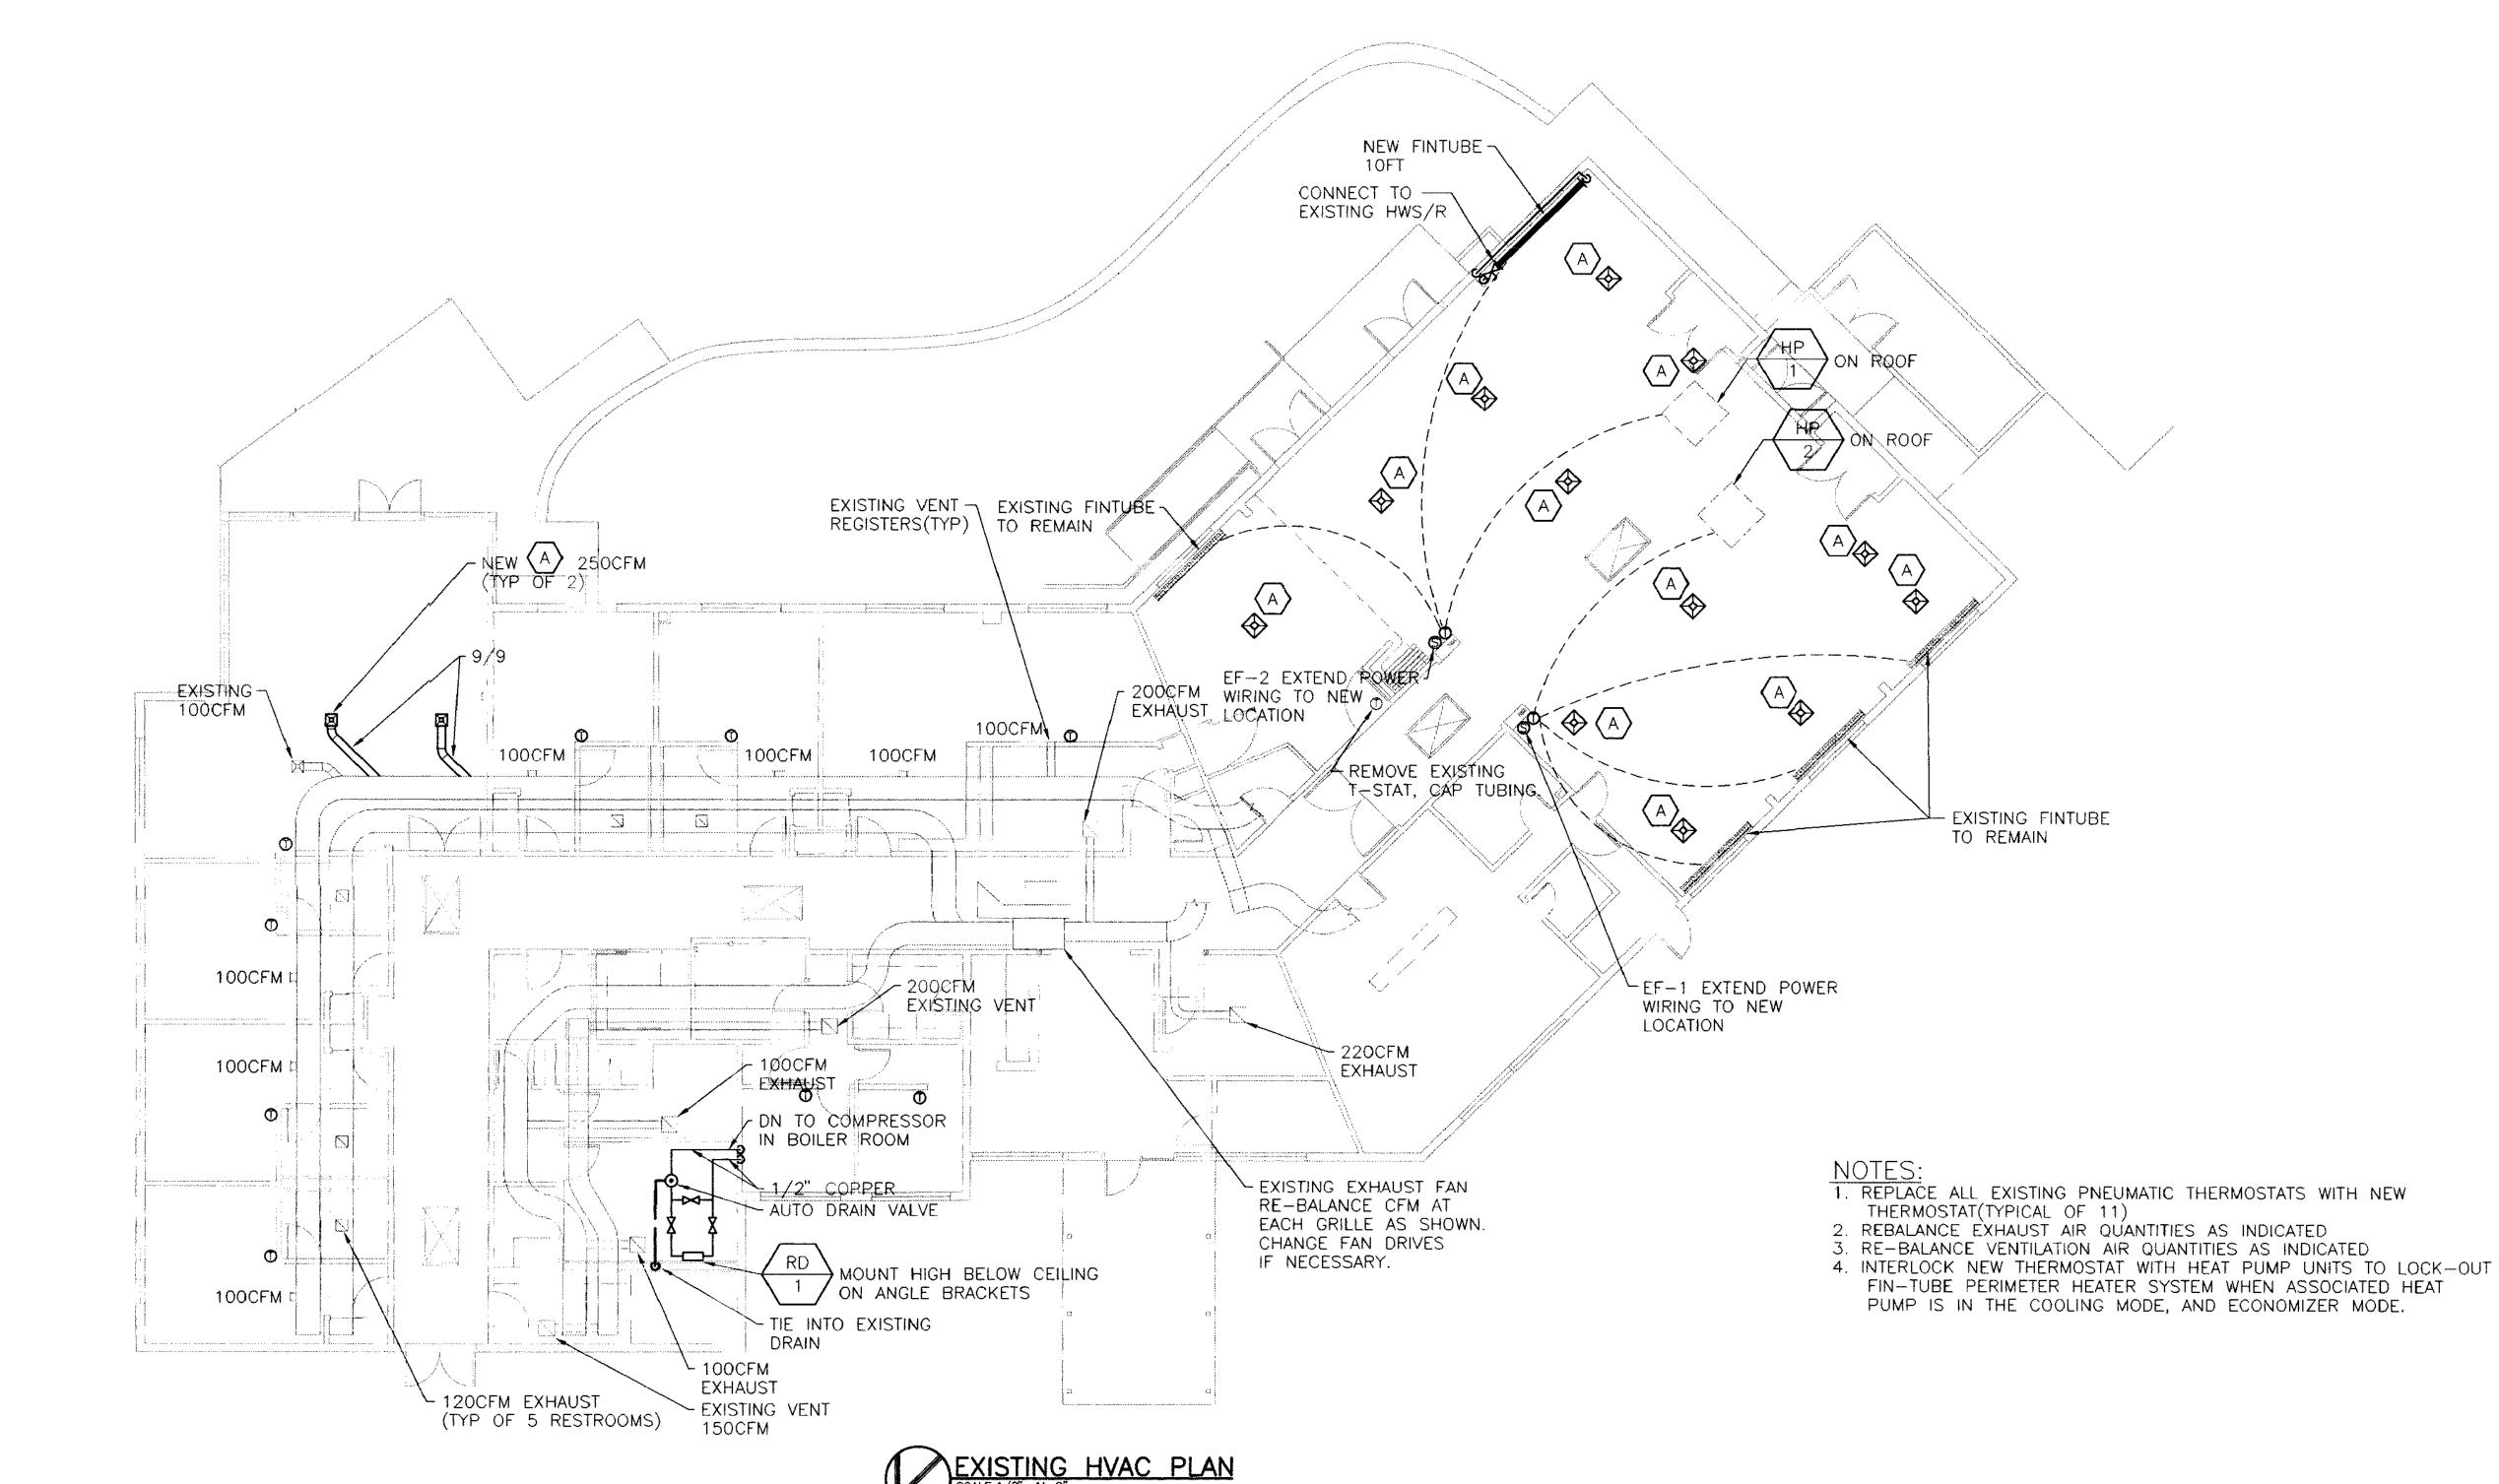
REVISIONS

BOTE BEENLEYICH

# EXISTING HVAC FLOOR PLAN

DRAWN: DRA
CHECKED: TEP
PROJECT NO.: 7134
S H E E T


M1.2





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CONTACT: MIKE HENABY
JOB NUMBER: 7134



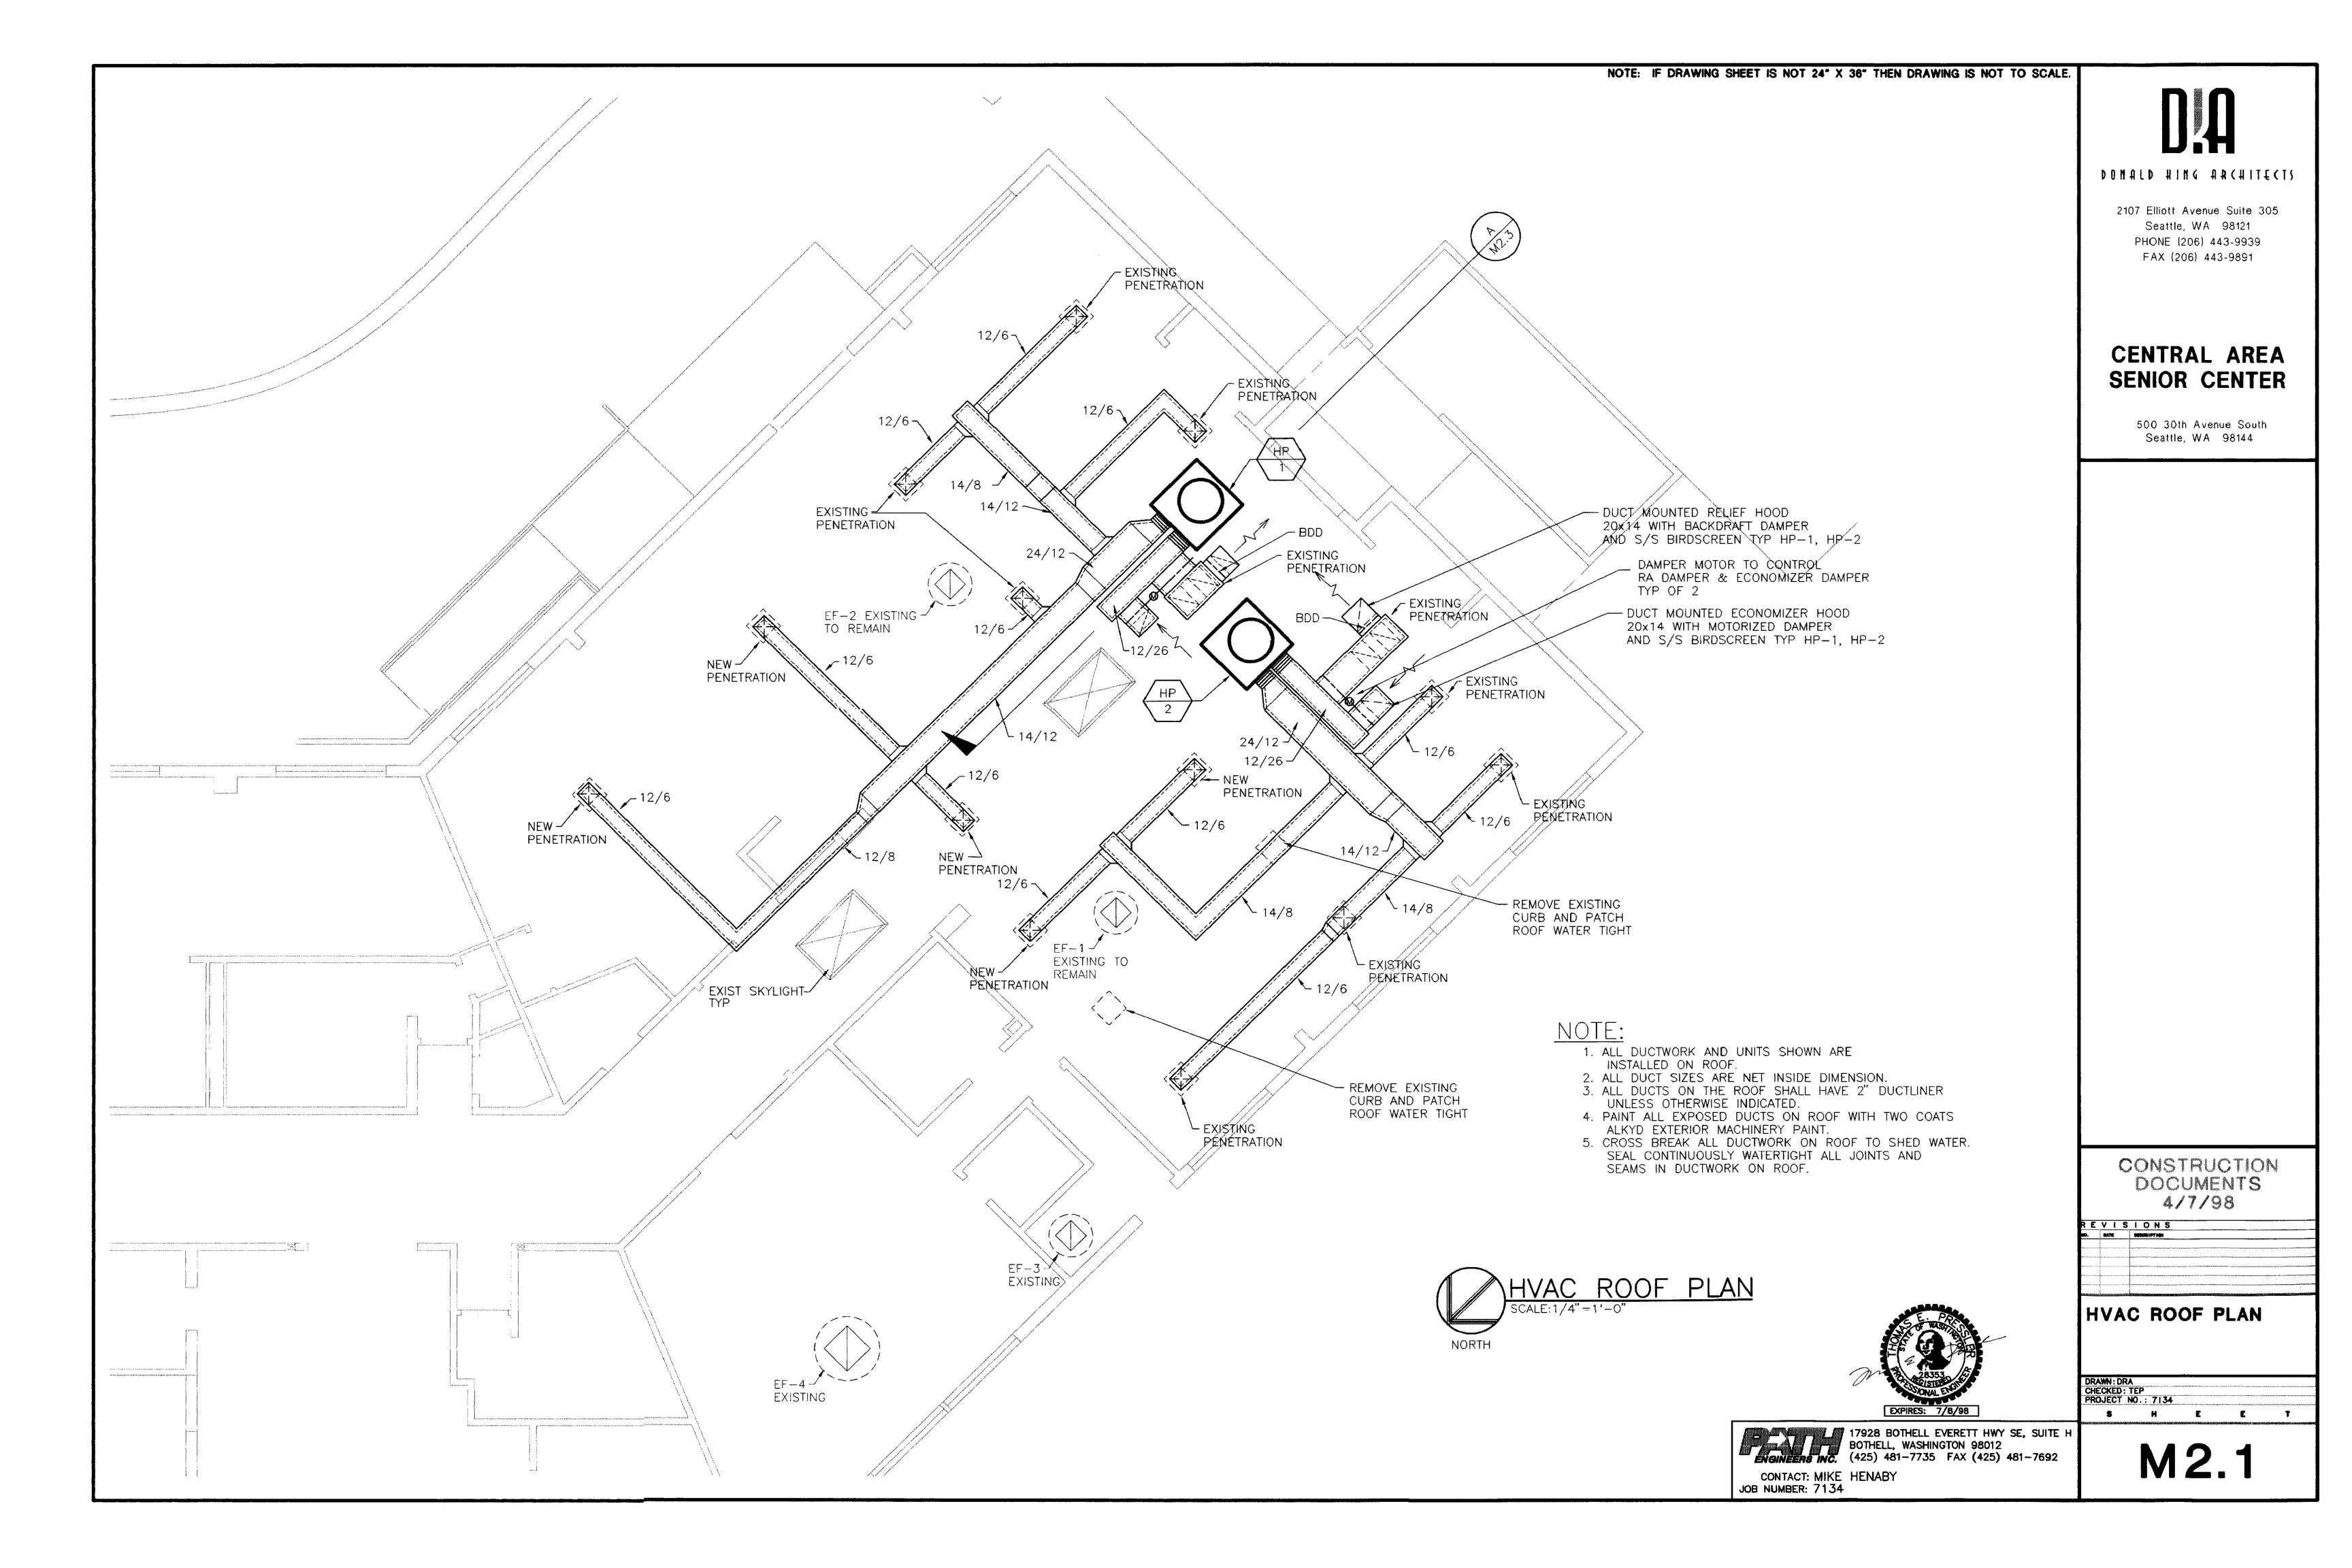


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# CENTRAL AREA SENIOR CENTER

500 30th Avenue South Seattle, WA 98144



BASEMENT MECHANICAL PLAN

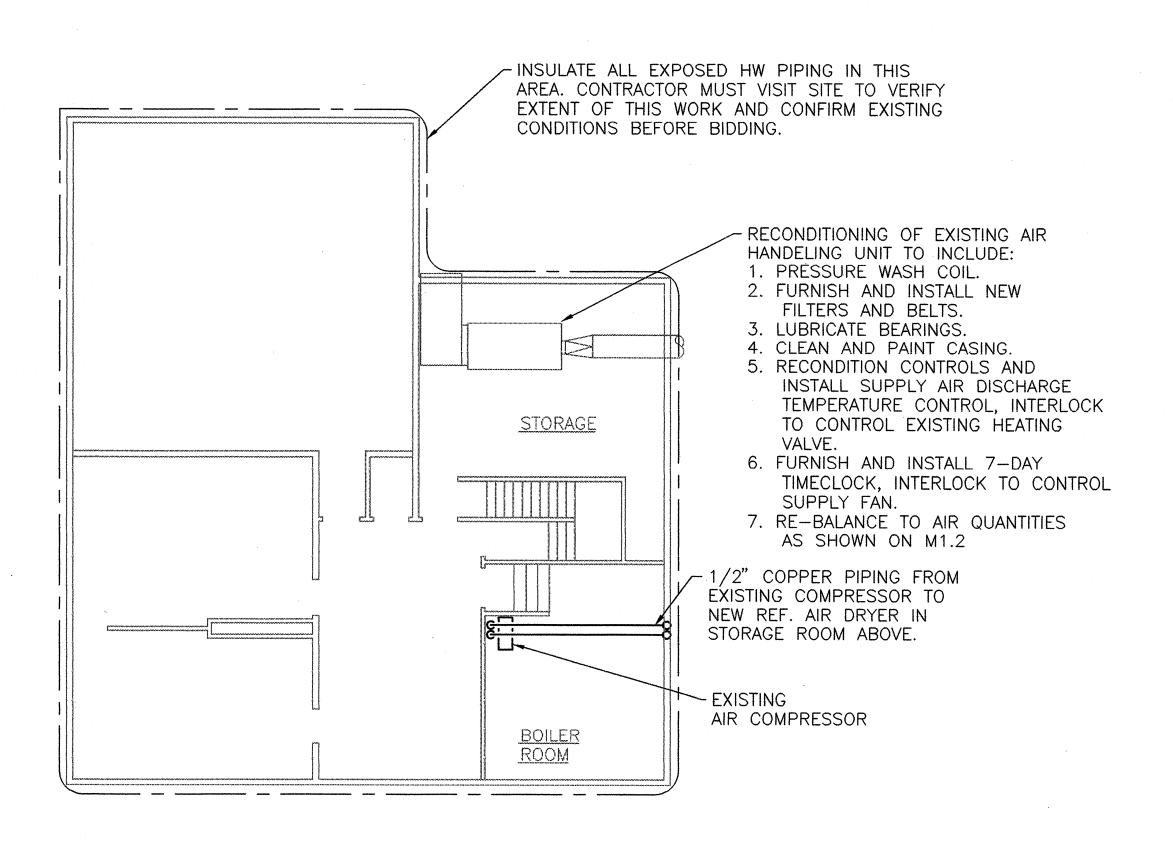CONSTRUCTION DOCUMENTS 4/7/98

REVISIONS

BASEMENT MECHANICAL PLAN

DRAWN: DRA CHECKED: TEP PROJECT NO.: 7134 S H E E T



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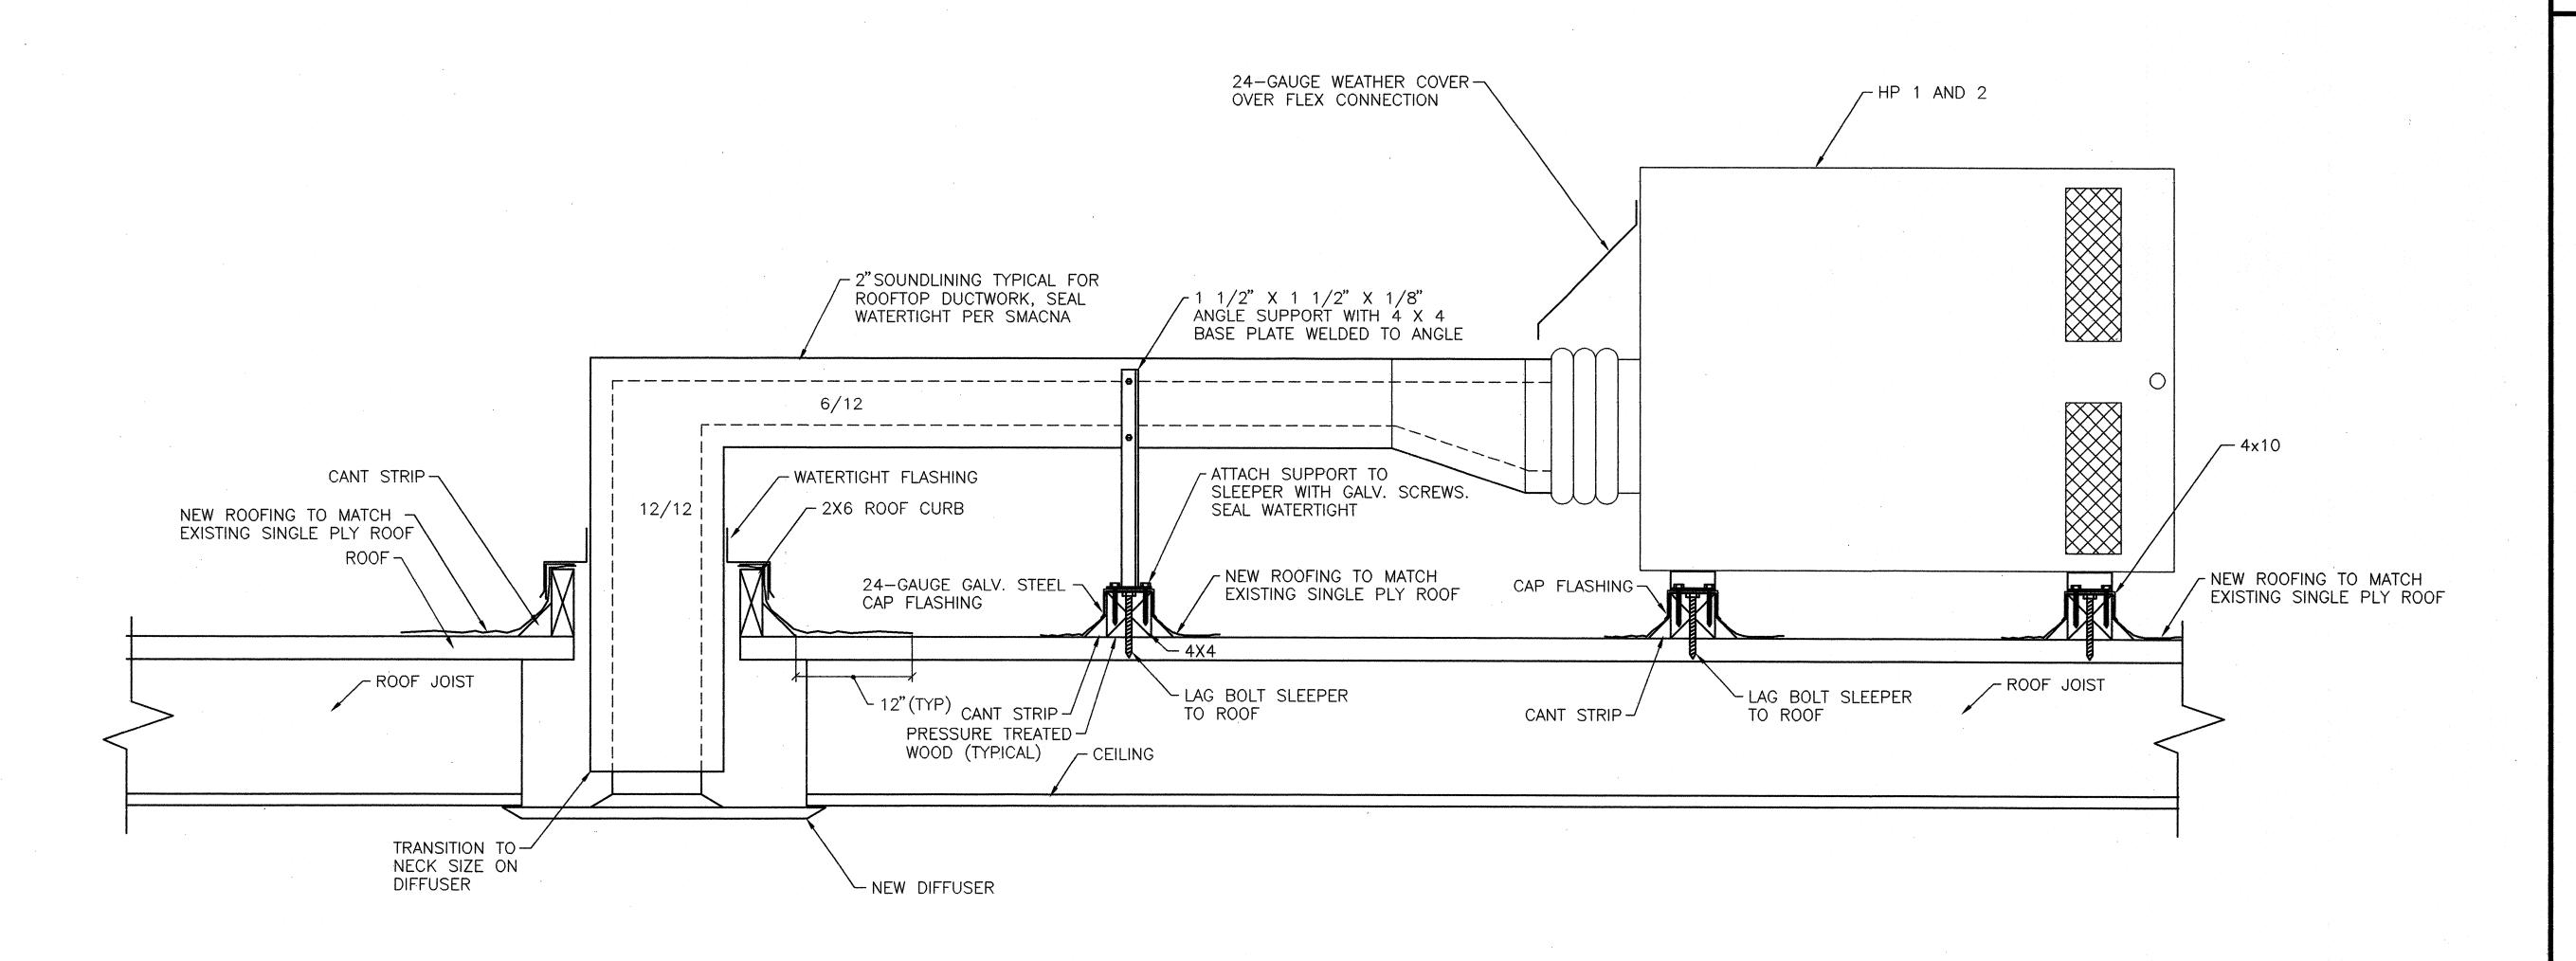
M2.2

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# CENTRAL AREA SENIOR CENTER

500 30th Avenue South Seattle, WA 98144



ROOFTOP HEAT PUMP AND PENETRATION DETAIL M2.3 SCALE: NO SCALE

NOTE: NOTES ON SHEET M2.1 APPLY TO THIS WORK.

CONSTRUCTION DOCUMENTS 4/7/98

REVISIONS

MECHANICAL DETAILS

DRAWN: DRA CHECKED: TEP PROJECT NO.: 7134 TO SALE HE SEE TO



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(425) 481-7735 FAX (425) 481-7692

M2.3

# GENERAL STRUCTURAL NOTES:

#### THE FOLLOWING NOTES APPLY EXCEPT WHERE SHOWN OTHERWISE

Uniform Building Code, 1994

LIVE LOADS Roof:

25 psf

Seismic Zone: Wind:

80 MPH, Exposure B

#### **FOUNDATIONS**

Maximum soil pressure 2000 psf. All footings to bear on firm undisturbed native soil below organic, surface soils and shall be lowered if suitable soil is not found at elevations shown on drawings. Backfill to be thoroughly compacted with structural fill to 90%. Provide 2 #5 (minimum) continuous bottom of all walls and footings.

#### CONCRETE

#### MAX WATER/CEMENT RATIO

				MINIMUM	
	<u>f'c</u>	NON-AIR-ENT	AIR-ENT	SACKS/C.Y.	<u>REMARKS</u>
Footings and foundations walls	2500	0.65	0.54	5 - 1/2×	
All structural concrete	3000	0.58	0.46	5 - 1/2	
Sidewalk slabs, exterior stairs	2500	0.65	0.54	5	Note 1
Setting bearing plates	5000			<b></b>	Masterflow 928/equal

- 1. Air-entraining agent (3% to 6%) to be used in all concrete flatwork exposed to weather.
- × Can be reduced 1/2 sack/cubic yard if not exposed to weather.

#### REINFORCING STEEL

ASTM A615 grade 60, except £3 and £4 stirrups, ties, and elbow bars to be grade 40. Reinforcing steel details shall be prepared by an experienced detailer and conform to standard practice outlined in ACI Report 315.

NOTE: Reinforcing steel not specifically shown shall be assumed typical as similar sections and details where reinforcing is shown.

#### CONCRETE COVER OF REINFORCING

- 3" Concrete poured against earth.
- 2" Formed concrete with earth backfill. 1 - 1/2" Beams and columns (stirrups, ties), outside face of walls exposed to weather, slabs on moisture barrier.

Extend horizontal wall steel to 2" from outside face and lap with elbow bars (30 diameters) of same size and spacing. Lap outside face (standard lap) only at corners. Wall stubs shall be same size and spacing as vertical steel.

#### SLABS AND BEAMS

Non structural slabs on grade to be 4" thick placed on gravel fill and reinforced with 6 x 6 W2.9 mesh unless otherwise noted on the plans.

Structural Grade ASTM A36, Fy = 36,000 psi. Structural tubing columns ASTM A500, grade B, Fy = 46,000 psi. All steel except steel embedded in concrete shall be given one shop coat of approved paint. Welds to be 3/16" minimum continuous fillet using E70 electrodes by certified welders. Steel to steel bolted connections are shown to be bearing-type connections using A-325 bolts with threads included in the shear plane, except where noted (A325)F shall be friction-type connection with bolts tensioned and using appropriate hardened steel washers as required by AISC standards. Where not specifically shown by detail, connections shall be bolted frame beam connections per AISC standards. Hole size shall be in accordance with AISC specification for bearing connection and bolts shall be tightened to snug-tight condition. During erection, structural steel shall be secured from collapsing with temporary bracing. Where expansion anchors are specified, the contractor shall submit to the Structural Engineer manufacturer's literature describing the anchors and listing recognized allowable shear and tension values.

#### SCOPE OF STRUCTURAL ENGINEERING SERVICES

The Structural Engineer has performed the structural design and prepared the structural working drawings for this project. The construction must be performed in strict accordance with the structural drawings. Any deviation from the drawings must be approved in writing by the Structural Engineer. Errors and/or omissions found on the structural drawings must be brought to the Structural Engineer's attention immediately.

The Structural Engineer is responsible for the design of the primary structural system, except for any components noted above. Responsibility for any secondary structural and non-structural systems not shown on the structural plans rests with someone other than the Structural Engineer.

The structure shown on these drawings is structurally sound only in its completed form. The Contractor shall provide all necessary bracing to stabilize the building during construction.

The Structural Engineer is not responsible for, and will not have control of, construction means, methods, techniques, sequences or procedures, or for safety precautions and programs in connection with the construction work, nor will he be responsible for the Contractor's failure to carry out the construction work in accordance with the contract documents.

Field measurements and the verification of field dimensions are not part of the Structural Engineer's responsibility. The Contractor must check all (assumed) existing conditions shown on these drawings for accuracy and notify the Structural Engineer of any discrepancies.

Omissions from the drawings or specifications or the inadvertent mislabeling of details of work which are manifestly necessary to carry out the intent of the drawings and specifications, or which are customarily performed, shall not relieve the Contractor from performing such omitted or inadvertent mislabeled details of the work but they shall be performed as if fully and correctly set forth and described in the drawings and specifications.

#### SPECIAL INSPECTIONS

In addition to general inspections by UBC section 108, the following Special Inspections shall be performed in conformance with UBC section 1701 and are required during the following types of work:

#### CONCRETE (f?c > 2500 psi):

- × taking of concrete test specimens,
- × placing of reinforced concrete.

DONALD KING ARCHITECTS

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# CENTRAL AREA SENIOR CENTER


500 30th Avenue South Seattle, WA 98144

APPROVED FOR ADVERTISING

DWIGHT D. DIVELY


Director of Executive Services


SEATTLE, WA \_\_\_\_\_\_19\_\_\_

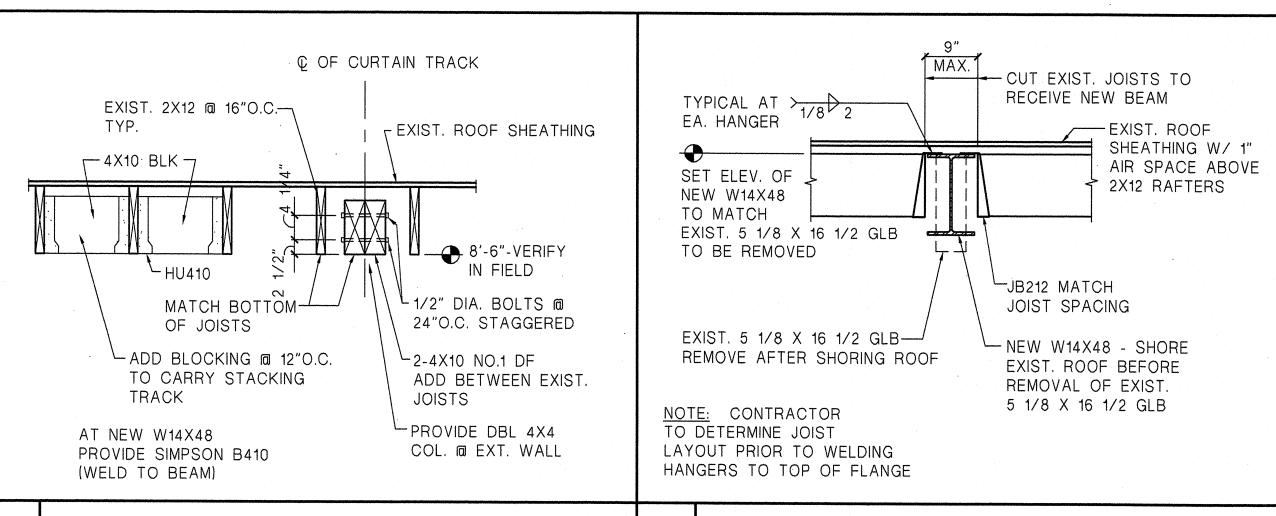


SCALE: 3/4"=1'-0"

CONTRACTING COMPLIANCE MANAGER APPROVED BY EXECUTIVE SERVICES DEPARTMENT CITY OF SEATTLE DIR. FACILITY SERVICES DIV. SCALE: 3/4":1'-0" DIR. ARCHITECTURE AND ENGINEERING DATE F:\CFP\CSD\DWGS\CDS\DTLS\DRAWINGX.DWG PHASE II BID SET - W14X48 6/22/98 REVISIONS

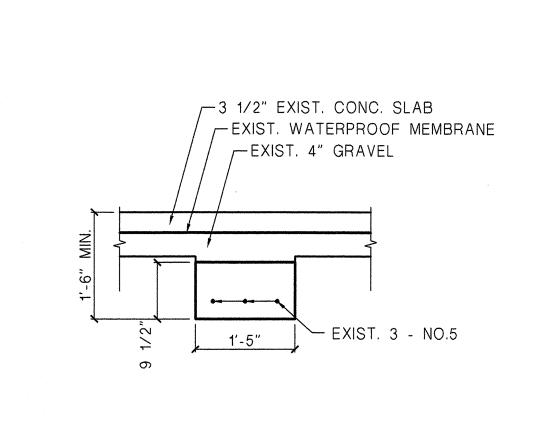

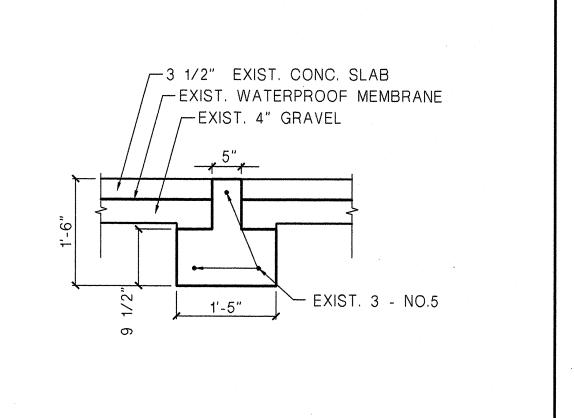

3 OPER. PART. TRACK SUPPORT

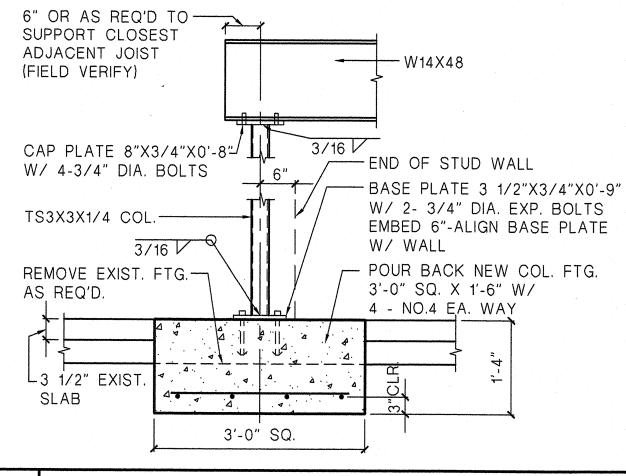

STRUCTURAL DETAILS

DRAWN: CDL CHECKED: MAJ PROJECT NO.: 9719 S H E E T

TYP. FOUNDATION @ EXIST. DOORWAY SCALE: 3/4"=1"-0"

**BEARING PARTITION** 

TYP. FOUNDATION @ EXIST. INT.

2 TYP. COL./BEAM/FOOTING DETAIL SCALE: 3/4"=1'-0" SCALE: 3/4"=1'-0"

**BEAM SECTION**